

The undersigned has reviewed and takes responsibility for this design , and has the qualifications and meets the requirements set out in the Ontario Building Code to be designer.

Qualification Information:

Alain Lavoie 24109 BCIN Name Signature



DRAWING SCHEDULE

SHEET TITLE

A8

A9

3D VIEW & PROJECT INFO **GENERAL NOTES** А3 FOUNDATION PLAN

Α4 BASEMENT PLAN GROUND FLOOR PLAN

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CONSTRUCTION DETAILS A13 FIREPLACE DETAILS A14 A15 STUCCO DETAILS

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P.ENG STAMP FOR DESIGN OF PRIPARY STRUCTURAL ELEMENTS ONLY. DEC. 6, 2019 BY: BLANCHARD LETENDRE ENGINEERING LTD.; JOB No.: 19-376

PROJECT AREA: ERAMING WISTONE & STUCCO GROUND FLOOR 2379 sqft GARAGE: 572 sqft 596 sqft COURT YARD: 185 sqft REAR DECK: 290 sqft 2379 sqft FOUNDATION (HOUSE): FOUNDATION (GARAGE): 596 sqft FOUNDATION TOTAL: 2975 sqft

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1. ARCHITECTURAL DESIGN

It is important to understand that the design and plan which was produced on your behalf by Paragon were designed with a home package-kit structural system. It includes our exclusive wall system which has an R-32 insulation factor. Those plans were also produced with complete structural engineering, mechanical engineering, pre-engineered roof trusses, pre-engineered floor system and a very custom home via and with Paragon home package-kit.

Production of your home package-kit will begin, and we need 6 to 8 weeks to produce all elements included in your home package-kit.

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CONSTRUCTION PROJECT MANAGEMENT BY PARAGON HOMES

CUSTOM ENGINEERED HOME PACKAGES-KIT BY PARAGON HOMES

12/6/2019	Final Plan Issued to Client	08

FOR ALL TECHNICAL ISSUE OR QUESTIONS, CONTACT PARAGON HOMES BEFORE CONTINUING THE WORK.

THE CONTRACTOR WILL BE LIABLE TO CONFIRM ALL DIMENSIONS AND CONDITIONS AFFECTING THE WORK SITE AND WILL BE SOLELY RESPONSIBLE FOR THE ACCURACY OF MEASUREMENTS AND OBSERVATIONS.

THE CONTRACTOR WILL REPORT ANY ERRORS. OMISSIONS OR DEFECT TO PARAGON HOMES BEFORE THE COMMENCEMENT OF WORK.

CHECK EXISTING CONDITIONS ON SITE AND ADJUST AS

ALL WORK TO BE PERFORMED.

- ACCORDING TO ESTABLISH AND STANDARDS AS REQUIRED BY CODES. - BY RULES OF THE ART.

- IF THERE IS A PLACE IN ACCORDANCE WITH THE RECOMMENDATIONS OF THE MANUFACTURERS OF THE MATERIAL OR EQUIPMENT.

QUEBEC CONTRACTORS WILL BE HELD LIABLE TO THEIR SPECIFIC SUB-TRADES RESPONSIBILITIES WHEN BUILDING THIS CUSTOM HOME. THE SAME SHALL BE APPLICABLE FOR ONTARIO SUB-TRADES.

DO NOT SCALE THE DRAWINGS.

m/d/y	DESCRIPTION	REV
10/25/2019	Construction Plan Prelim Stage	01
	Construction Plan Prelim Stage2	02
	Issued to Truss Manufacturer	03
THE RESERVE AND ADDRESS OF THE PARTY OF THE	Construction Plan Prelim Stage3	04
11/11/2019	Issued for Structural Review	05
11/21/2019	Modified Bathrm & Lowered Roof	06
	Revised to Architect Comments	07

CASA BORRACCI

DESIGNED BY: ROBERTSON MARTIN ARCHITECTS

PROJECT INFORMATION **NEW RESIDENCE** for M.& Mrs BORRACCI 880 Duberry St. Ottawa DRAWING TITLE

3D VIEW & PROJECT INFO PROJECT DIRECTOR FILE NAME N/A FRANK MURRAY

> PROJECT NUMBER AL-B9-157

As Shown

Oct 2019 DRAWING NUMBER

A1 of 19

IMPORTANT NOTES

CARPENTRY

AND PLUMBING, ETC.

WHEREVER POSSIBLE

VENTILATION

LOADING

USE OF AREA

ROOF <40ft

ROOF >40th

INTERIOR STAIR

BALCONY, DECK

FLOOR

MANUFACTURER OF TRUSSES.

UNLESS OTHERWISE SPECIFIED ON PLAN: - FRAMING LUMBER SHALL BE SPF No. 2 OR

THAN LVL. SHALL BE SPF No 2 OR BETTER:

BETTER UNLESS OTHERWISE SPECIFIED ON PLAN,

AND LINTEL SIZES SHOWN ON THE DRAWINGS, OTHER

JOIST SHALL BE PLACE TO ACCOMMODATE HEATING

OWNER/BUILDER TO OBTAIN SHOP DRAWINGS FROM

- LUMBER FLOOR JST WITH SPANS OF MORE THAN 7 FT.

MAX: UNLESS SHEATING OR STRAPPED BOTH SIDES WITH

WITH WOOD. BRIDGING SHALL BE 2x2 DIAGONAL TYPE

- FLUSH FRAMED WOOD MEMBERS SHALL BE ANCHORED.

WITH JOIST HANGERS UNLESS OTHERWISE SPECIFIED.

DIMENSIONS ARE FROM THE OUTSIDE FACE OF STUDS.

ROOF INSULATION IS A COMBINATION OF SPRAY FOAM.

ALL ROOF SPACES SHALL BE VENTILATED WITH SOFFIT

ROOF VENTS AND EQUALLY DISTRIBUTED BETWEEN

THE TOP OF ROOF SPACE AND SOFFITS AS SHOWN ON

ELEVATION DWG. UNLESS OTHERWISE SHOWN ON PLANS

LIVE LOAD

40 PSF

46 PSF

40 PSF

40 PSF

40 PSF

DEAD LOAD

19 PSF

19 PSF

15 PSF

10 PSF

WALLS AND CEILINGS BETWEEN RESIDENCE AND

ATTACHED GARAGE SHALL BE INSULATED.

UNDER ROOF SHEATING AND RIGID INSULATION ON TOP.

- PLATES ARE TO BE ANCHORED TO CONCRETE WITH

1/2" ANCHOR BOLTS @ 72" MAXIMUM SPACING.

INSULATION & ROOF

SHALL BE BRIDGED AT MID SPAN OR AT 7 FT. O.C.

CODES & STANDARDS

DO NOT SCALE THE PLASS - ALL WORKMANSHIP IS TO BE OF A STANDARD EQUAL IN ALL RESPECTS TO 60000 PRACTICE - AT THE TIME OF PREPARATION, THIS PLAN WAS DRAWN IN ACCORDANCE WITH THE CURRENT EDITION OF THE ONTARIO BUILDING CODE. IT IS THE RESPONSIBILITY TO INSURE THAT CHANGES TO THE COMMON TO THE COMPLIED WITH AND ALL AMENDMENTS ARE INCORPORATED IN THE CONSTRUCTION ALL WORK SHALL CONFORM TO BYLANS ORDINANCES AND REGULATIONS

PRIOR TO PROCEEDING with construction, the BUILDER MUST VERIEVALLI MEASMATIAN THE REVENANCE AND SPECIFICATIONS W TAKE PRECEDENCE OVI - SCALE MEASUREMENTS - ANY VARIANCES FROM 1 FICATIONS OR FROM C(DITIONS ENCOUNTERED AT THE JOB SITE SHALL BE RESOLVED BY THE OWNER.

BUILDER AND SUCH SOLUTIONS SHALL BE THEIR SOLE RESPONSIBILITY - CONSTRUCTION LOADS BY INTERIM STORAGE OF MATERIALS SHALL NOT BE

ALLOWED TO EXCEED THE DESIGN CONTROL THE BUILDER IS TO PROVIDE ALL NECESSARY TEM-PORARY SUPPORT FOR TO THE COMPLETION OF VERTICAL AND LATERAL LOAD SYSTEMS

THE OWNER/BUILDER SHALL BE RESPONSED FOR THE CORRECT SITTING OF THE HOUSE ON THE

THE OWNER/BUILDER TO SUPPLY ALL MISSING LOT, LEGAL DESCRIPTION, NORTH DIRECTION, MAIN STREETS AND LOCATIONS OF SERVICES

THE OWNER/BUILDER TO BE RESPONSED. CONDITIONS SUCH AS STORE BEARING CAPACITY DEPTH OF FROST PENEJIRATION, WATER JABLE OR BURIED STRUCTURES

MISCELLANEOUS

DOORS & WINDOWS TRIM FLOOR FINESHES, WANTES BATH SPLASH AND KITCHEN CARNETS TO MEET SPECIFICATIONS OF OWNERS THE PROPERTY OF THE P

APPROVED LOCKING MEDICINE CARRIET TO BE INSTALLED IN AT LEAST ONE BATHROOM.

COAT AND CLOTHES CLOSET SHALL HAVE AT LEAST ONE ROD AND SHELF. LINEN CLOSET SHALL HAVE 5 ADJUSTABLE SHELVES WHERE POSSESSES BROOM CLOSET SHALL HAVE ONE SHELF

CERAMIC AND PLASTIC TILE INSTALLED ON WALLS AROUND BATHTUBS OR SHOWERS SHALL BE APPLIED OVER MOISTURE RESIS

GLASS & WINDOWS

- GLASS SLIDING PATIO DOORS ARE TO BE OF TEMPERED GLASS.

ALL WINDOWS SHALL BLAS PER WINDOWS SCHEDULE.

HEATING & VENTILATION

- BUILDER OR HEATING CONTRACTOR TO PROVIDE HEAT LOSS CALCULATIONS AND LAYOUT

- THE MECHANICAL & ELECTRICAL DESIGN SHALL BE THE CONTRACTOR IT IS THE RESPONSIBILITY OF THE CONTRACTORS TO ENSURE THAT THE RESERVENCE WERE DESIGN AND INSTALLED AS PERCONE

ELECTRICAL

INSTALLATION OF ELECTRICAL TENS MUST COME V WITH LOCAL ELECTRICAL CODES AND REGULATIONS IN ALL RESPECTS.

OUTLET LOCATIONS IF § 1000 PLANS COMPANY AND THE CODE REQUIREMENTS AND ARE TO BE USED AS A GUIDE ONLY ADJUST ACCORDING TO OWNERS OR LOCAL AUTHORITIES REQUIREMENTS.

BATHROOM FANS SHALL BE FOUR FAND ALL EXHAUST FAN TO BE C/W THERMA ANTI-SWEAT VAPOUR BARRIER MENTING OUTSIDE

AUST OUTSIDE

BASEMENT NOTES

BN1> 4"Ø WEEPING TILE IN A SOX TO BE INSTALLED AT THE PERIMETER OF FTG. AND COVERED/W 6° OF CLEAR CRUSHRUN STONE

BN2> 6 MIL VAPOR BARRIER SHALL BE INSTALLED UNDER BASEMENT SLAB. SEE F2 ON A10

BN3> MOISTURE BARRIER IS REQ'D BETWEEN WOOD & CONCRETE UNLESS P/T WOOD IS USED.

BN4> DBL RIM JSTS SHALL BE INSTALLED OVER FOUNDATION WALL PARALLEL TO FLOOR JSTS

BN5> HOT WATER TANK SHALL BE SECURED TO HOUSE STRUCTURE

BN6> HEATING & MECHANICAL VENTILATION SYSTEM SHALL BE INSTALLED AS PER CODE AND MANUFACTURER'S SPECS SHALL BE LEFT ON SITE.

BN7> O.B.C. Sec. 9.9.10.1.(1) EXIT WINDOW (BASEMENT) Shall be Openable from the Inside Without the Use of Tools and Provides an Individual Unobstructed Open Portion having a Minimum Area of 0.35m2 with no Dimensions Less than 380mm. When the Window Opens into a Window Well a Clearance of 22" (550mm) shall be provided in Front of Window

SOIL BEARING ALL FOOTING AND PADS MUST BE

CARRIED DOWN TO ELEVATIONS SPECIFIED ON UNDISTURBED SOIL HAVING 1567 PSF (75 KPa) BEARING CAPACITY, ALLOWABLE SOIL BEARING MUST BE CONFIRMED BY A GEOTECHNICAL ENGINEER.

POURED CONCRETE

A> CONCRETE WORK SHALL CONFORM TO CSA CAN3-A23.1.2.3 WITH MAXIMUM AGGREGATE SIZE OF 3/4"(20mm) AND ULTIMATE STRENGTH AT 28 DAYS OF 20 Mpa (2900 PSI) WALLS & FTG. 25 MPa (3625 PSI) BASEMT SLAB

 32 MPa (4650 PSI) GARAGE & EXT, SLAB B> FOR CONCRETE EXPOSED TO CYCLES OF FROST AND DEFROST, ENTRAINED AIR MUST BE BETWEEN 4.5 to 7% AND AS PER CAN3-A266.1 M78

C> CONCRETE IS TO HAVE A MAXIMUM SLUMP OF 100mm (4")

D> FOR NORMAL STRUCTURAL CONCRETE FULL CURING PERIOD IS 28 DAYS. IF FOR ANY REASON, THE CONTRACTOR NEEDS TO DISMANTLE THE FORMWORK OR APPLY ANY ADDITIONAL LOADS BEFORE CURING PERIOD IS OVER HE MUST GET A WRITTEN CONSENT FROM A STRUCTURAL ENGINEER.

E> NO LIVE LOAD OR DEAD LOAD OTHER THAN THE OWN WEIGHT OF THE CONCRETE ELEMENT SHALL BE APPLIED DURING CURING PERIOD

> CONTRACTOR MUST GIVE ENGINEER 24H. WRITTEN NOTICE BEFORE POURING CONCRETE WHEN ENG. SEAL IS ON PLAN

G> REINFORCING STEEL MUST MEET CSA G30.18 AND REINFORCING WELDED WIRE FABRIC MUST MEET G30.3 AND IS SUPPLIED IN SHEETS

→ ALL REBARS MUST BE 400 Mpa (60 Ksi), CLEAN OF ANY DIRT, AND LAID AS SHOWN ON DRAWINGS.

REBARS CONC. COVER > MIN. CLEAR COVER SHALL BE

A) CAST AGAINST AND PERMANENTLY EXPOSED TO EARTH: 75mm (3°) B) EXPOSED TO EARTH OR WEATHER: 20M TO 55M BARS 50mm (2") 15M BARS, 16mm WIRE

AND SMALLER 40mm (1 1/2") J- OVERLAPPING OF REBARS SHALL BE: FOR 15M AND SMALLER = 500mm (20") FOR 20M AND BIGGER = 600mm (24*) K> IN WALLS, PROVIDE CORNER REBARS OF 600mm x 600mm (24" x 24")

CLEAR SPAN

L1 < 2.30m

L2 2.48m

L3 3.08m

L4 3.24m

SPACED SAME AS WALL REINFORCEM'T

STEEL ANGLES FOR MASONRY VENEER

< 7"-6" (90")

8'-0" (96")

10'-0" (120")

10"-7" (127")

FOUNDATION NOTES | FLOOR PLAN NOTES

N1> ALL EXTERIOR WALLS ARE IN 2x6 STUDS @ 16"c/c AND ALL INTERIOR WALLS ARE IN 2x4 STUDS @ 16"c/c (SPF#1 or #2) UNLESS OTHERWISE SPECIFIED.

N2> NAT. GAS FIREPLACE MANUF. SPECS SHALLL BE LEFT ON SITE FOR INSPECTOR. (IF FIREPLACE IS INSTALLED)

N3> INSULATE AND CONTINUE VAPOUR BARRIER WHERE INTERIOR WALLS MEETS WITH EXTERIOR WALLS.

N4> PROVIDE CAULKING AT ALL EXTERIOR WALL FRAMING WHERE FRAMING MEMBERS ABUT.

N5> ALL HOSE BIB SHALL HAVE A BACK FLOW PREVENTER.

N6> ALL TOILET SHALL BE 6 LITRES PER FLUSH MAXIMUM, ADD BLOCKING IN WALL NEAR TOILET. SHOWER AND BATH TUB FOR FUTUR GRAB BAR AS PER BARRIER FREE DESIGN REQUIRMTS.

N7> HOT WATER SUPPLIED TO FIXTURES SHALL NOT EXCEED 499694D. (MIXING VALVE)

HOUSE FROM OUTSIDE SHALL BE EQUIPPED WITH DEADBOLT LOCK. PROVIDE SOLID BLOCKING ON BOTH SIDE OF DOOR JAMBS AT LOCK HEIGHT TO RESIST SPREADING BY FORCE.

N10> ALL OPENING IN RAILING & GUARDS SHALL BE DESIGNED TO PREVENT THE PASSAGE OF A 4" DIA. SPHERE AND

N11> DIVIDING WALL BETWEEN GARAGE AND HOUSE SHALL BE COVERED WITH 1/2" DRYWALL ON BOTH SIDE OF WALL AND DOUBLE TAPE JOINTS

AT OPENINGS.

N13> INDIVIDUAL MEMBER OF BUILT UP LINTELS SHALL BE FASTENED TOGETHER WITH A MIN. OF 3 1/2" NAILS IN A DOUBLE ROW SPACED @ 17 3/4" O.C. MAX.

MANUFACTURER'S PLAN FOR DETAILS IF WOOD LJOISTS ARE TO BE USED. N15> RANGE/COOKTOP HOOD & DRYER SHALL BE EQUIPPED WITH EXHAUST DUCT LEADING TO OUTSIDE

EXT. ANGLES FOR 4" BRICK & STONE

(Table 9.20.5.2.B)

L 3 1/2" x 3 1/2" x 1/4"

L4" x 3 1/2" x 1/4"

L 5" x 3 1/2" x 5/16"

L5" x 3 1/2" x 7/16"

L5" x 3 1/2" x 1/2"

L 6" x 3 1/2" x 1/2"

L 6" x 3 1/2" x 7/16"

ABBREVIATIONS LEGEND: ATTIC ACCESS A.B. ANCHOR BOLT BF BI FOLD BLOCK B.P. **BOTH WAYS** BEAM POCKET 3 1/2" CATHEDRAL CATH

COLUMN CASEMENT CONC C/C CENTER COMPLETE WIT DBL. DECO DOUBLE DIA. DIAMETER

DOUBLE JOISTS DOUBLE RIM JOISTS DOOR DISH WASHER E.E. ELEC EACH END ELECTRICAL ELEVATION EXTERIOR

EXISTING

FINISH GRADE

EXIST

N8>ALL DOORS GIVING DIRECT ACCESS TO

N9> DOOR GIVING ACCESS FROM GARAGE TO HOUSE SHALL BE METAL INSUL. COMPLETE/W SELF CLOSER, DEADBOLT AND WEATHERSTRIP

PREVENT CLIMBING.

IN GARAGE(TYP, FOR WALL & CEILI'G).

N12> WALL STUDS SHALL BE CONTINUOUS FOR THE FULL STOREY HEIGHT EXCEPT

N14> FRAMER TO REFER TO FLOOR JOIST

FIRE RATED FINISHED FOUNDATION WALL GIRDER TRUSS GA. GALV. GALVANIZED GS. GIRDER SUPPORT HGT HEIGHT HORIZONTAL HOUR H.E. HOOD EXHAUST INSULATION INT. INTERIOR JST JOISTS JOIST HANGER KIT. KITCHEN LINEN LAMINATED VENEER LUMBER LVL MEDICINE CABINET M.C. MECHANICAL MEAN ROOF HEIGH METAL THRESHOLD MANUFACTURER P4 = (4)2x6 STUD POST (3 Jack + MICROWAVE MINIMUM MTL. METAL O.H.D. OVER HEAD DOOR POUNDS PER LINEAR FOOT POUNDS PER SQUARE FOOT POUNDS PER SQUARE INCH PRESSURE TREATED PARTIN, PARTITION PLYWD PLYWOOD R.O. ROUGH OPENING

STEEL ANGLE SOLDIER BRICK SOLID CORE

SLIDING GLASS DOOR SQUARE FOOT SINGLE HUNG SIDELIGHT SIMPSON STRONG TIES 8.8.1 STIRRUPS STEEL SWC SOLID WOOD CORE

TH THICK TO FOUNDATION T.O.FTG.TOP OF FOOTING T.O.PL. TOP OF WOOD PLATE TRIPLE JOISTS TYP. TYPICAL US UNDERSIDE

VERT. VERTICAL WATER CLOSET WOOD

WD.

A DETAIL OR SECTION NUMBER A# SHEET NO. WHERE TO FIND I Electric Smoke Detector with Visual Signaling Device * Electric Smoke & Carbon

CO/ Monoxide Detector. * All Detectors Shall Re Interconnected with Each Other.

BP. Beam Pocket 4" Deep for 3 1/2" Beam Bearing CARRY ALL POINT LOAD DOWN

TO FOUNDATION WOOD POST/STEEL COL. LEGEND When NOT SPECIFIED, Standard

Support (BOTH END) of Header

Above Openings in Load Bearing Stud Wall is 1 JACK and 1 KING. P0 = 3"dia. x 0.25" HSS POST ANCHORED AT TOP & BOT.

P1 = 3"dia, STEEL TELEPOST ANCHORED AT TOP & BOT

P1a = REDJACK LIGHT DUTY TYPE 2 JACKPOST

P1b = BLACKJACK MEDIUM DUTY TYPE 2 JACKPOST T2JPMD

P1c = REDJACK HEAVY DUTY TYPE 2 JACKPOST T2JPHD

P2 = (2)2x6 STUD POST (1 Jack + 1 King NAILED TOGETHER)

P2a = (2)2x6 STUD POST (2 Kings NAILED TOGETHER) P3 = (3)2x6 STUD POST (2 Jack + 1 King NAILED TOGETHER)

P3a = (3)2x6 STUD POST (3 Kings NAILED TOGETHER)

1 King NAILED TOGETHER) P4a = (4)2x6 STUD POST

(4 Kings NAILED TOGETHER) P5 = 4x4 WOOD POST P/T

P6 = 6x6 WOOD POST P/T

P7 = 5 1/4" x 5 1/4" VERSA-LAM

P8 = 6x8 PINE TIMBER POST If Header is NOT Tight Under Top Plates, Solid Blocking to Match Support shall be Installed at Ends.

HEADER LEGEND: All Header To Be (2)2x10 with P2 UNLESS OTHERWISE NOTED.

H1 =(2)2x12 H4 =(2)2x10 H7 =(2)2x8 H2 =(3)2x12 H5 =(3)2x10 H8 =(3)2x8 H3 =(4)2x12 H6 =(4)2x10 H9 =(4)2x8 H10=(2)2x6 H11=(3)2x6 H12=(4)2x6

> . BLANCHARD 100228753 NCE OF

P.ENG STAMP FOR DESIGN OF PRIPARY STRUCTURAL ELEMENTS ONLY. DEC. 6, 2019

SOLID HARDWOOD FLOOR

FLOOR ASSEMBLY

WOOD DOOF

JOB No.: 19-376

BY: BLANCHARD LETENDRE ENGINEERING LTD.

DO NOT SCALE THE CRAWINGS. 1/26/2019 Revised to Architect Comments 11/21/2019 Modified Bathrm & Lowered Roof 06 11/11/2019 Issued for Structural Review 11/8/2019 | Construction Plan Prelim Stage3 11/6/2019 Issued to Truss Manufacturer 11/2/2019 Construction Plan Prelim Stage2 10/25/2019 Construction Plan Prelim Stage DESCRIPTION ON

F.M

MAISONS

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CONSTRUCTION PROJECT MANAGEMENT

BY PARAGON HOMES

CUSTOM ENGINEERED HOME

PACKAGES-KIT BY PARAGON HOMES

DESCRIPTION

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APPLICABLE FOR ONTARIO SUB-TRADES.

BUILDING THIS CUSTOM HOME. THE SAME SHALL BE

RECOMMENDATIONS OF THE MANUFACTURERS OF THE

QUEBEC CONTRACTORS WILL BE HELD LIABLE TO THEIR

REV.

REV.

LEGEND

DATE


(On) 1-613-789-0220

CASA BORRACCI

DESIGNED BY: ROBERTSON MARTIN ARCHITECTS

PROJECT INFORMATION **NEW RESIDENCE** for M.& Mrs BORRACCI 880 Duberry St. Ottawa DRAWING TITLE **GENERAL NOTES**

PROJECT DIRECTOR FILE NAME N/A FRANK MURRAY PLAN VIEW DATE PROJECT NUMBER Oct 2019 AL-B9-157 INTERIOR DOOR JAM REVEAL DRAWING NUMBER DETAIL SCALE: 2"=1'-0" As Shown **A2** of 19

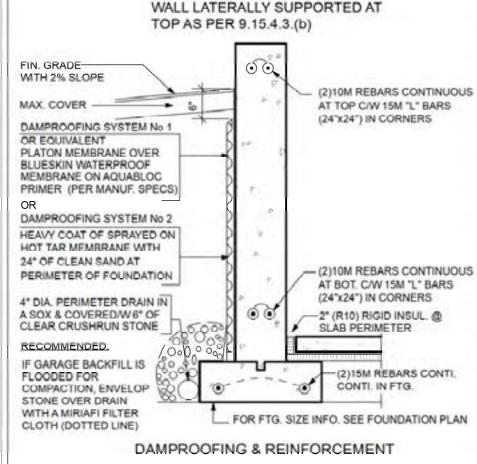

P.S.: FOR WALL NOT LATERALLY SUPPORTED AT TOP (Ex: Wall Around Stair in a Garage or Kneewall on a Found.) See Other Details

GD1

L10 4.25m

L7 3.77m 12'-4" (148") L8 3.82m 12'-8" (150") 13'-1" (157") L9 3.99m

L6 3.54m 11'-7" (139")

L5 3.33m 10'-11" (131") L 127 x 89 x 13 L 152 x 89 x 11 L 152 x 89 x 13

L 152 x 102 x 13 L6" x 4" x 1/2" L7" x 4" x 7/16" L 178 x 102 x 11 13'-11" (167") L7" x 4" x 1/2" L 178 x 102 x 13

L89 x 89 x 6.4

L 102 x 89 x 6.4

L 127 x 89 x 7.9


L 127 x 89 x 11


P.S. STEEL ANGLES SHALL HAVE 6" MIN. BEARING AT BOTH ENDS


TYPICAL FOUNDATION DETAIL SCALE: N.T.S.


-(2)15M Rebar (Typ.) -(2)15M Rebar (Typ.) Footing **ELEVATION VIEW** -(2)15M Rebar (Typ.) Window **PLAN VIEW** Poured Concrete


FOUNDATION WALL REINFORCEMENT AT BASEMENT WINDOW W01, W02 & W0 SCALE: 3/16"=1'-0"

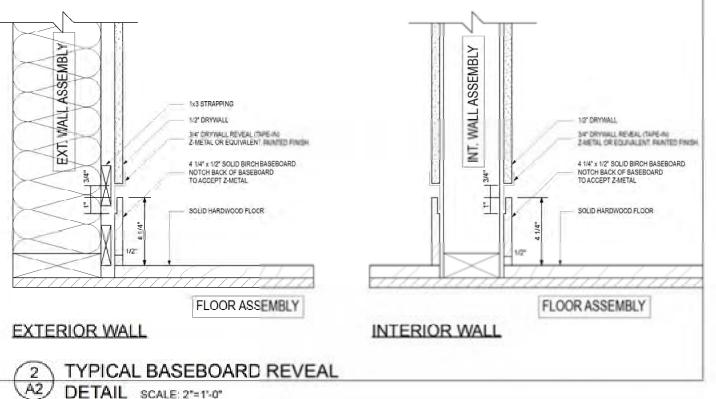

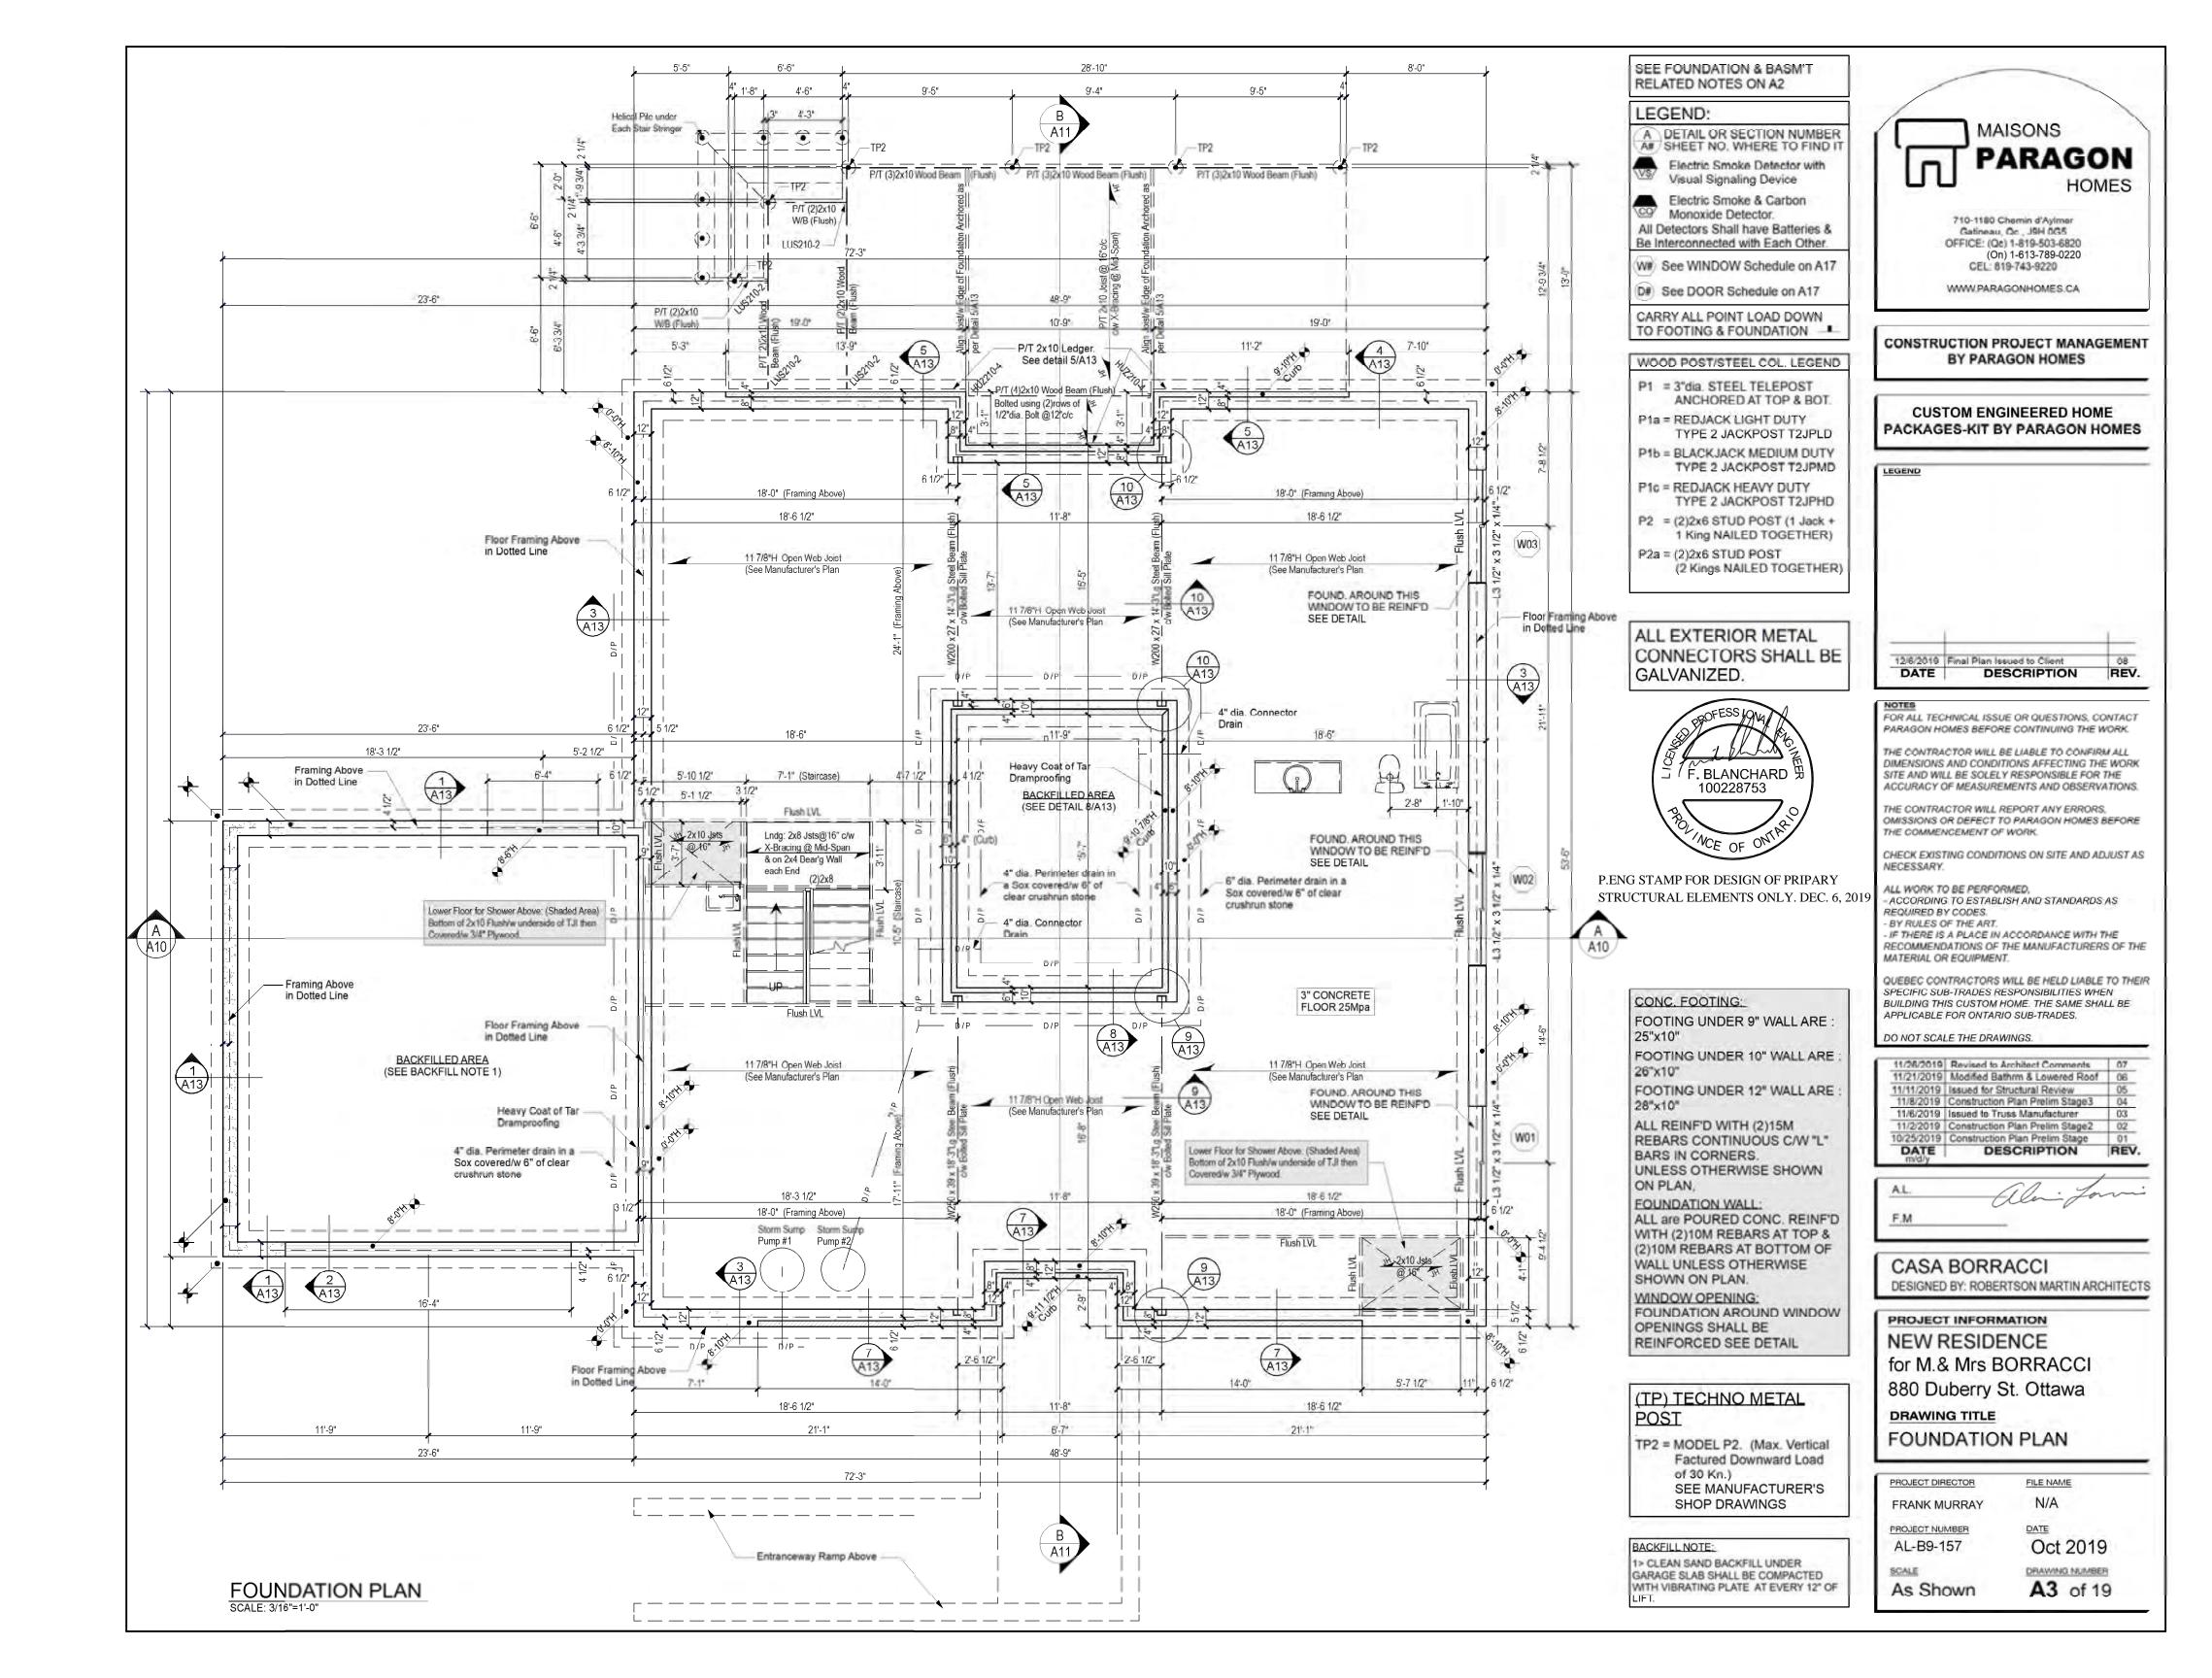


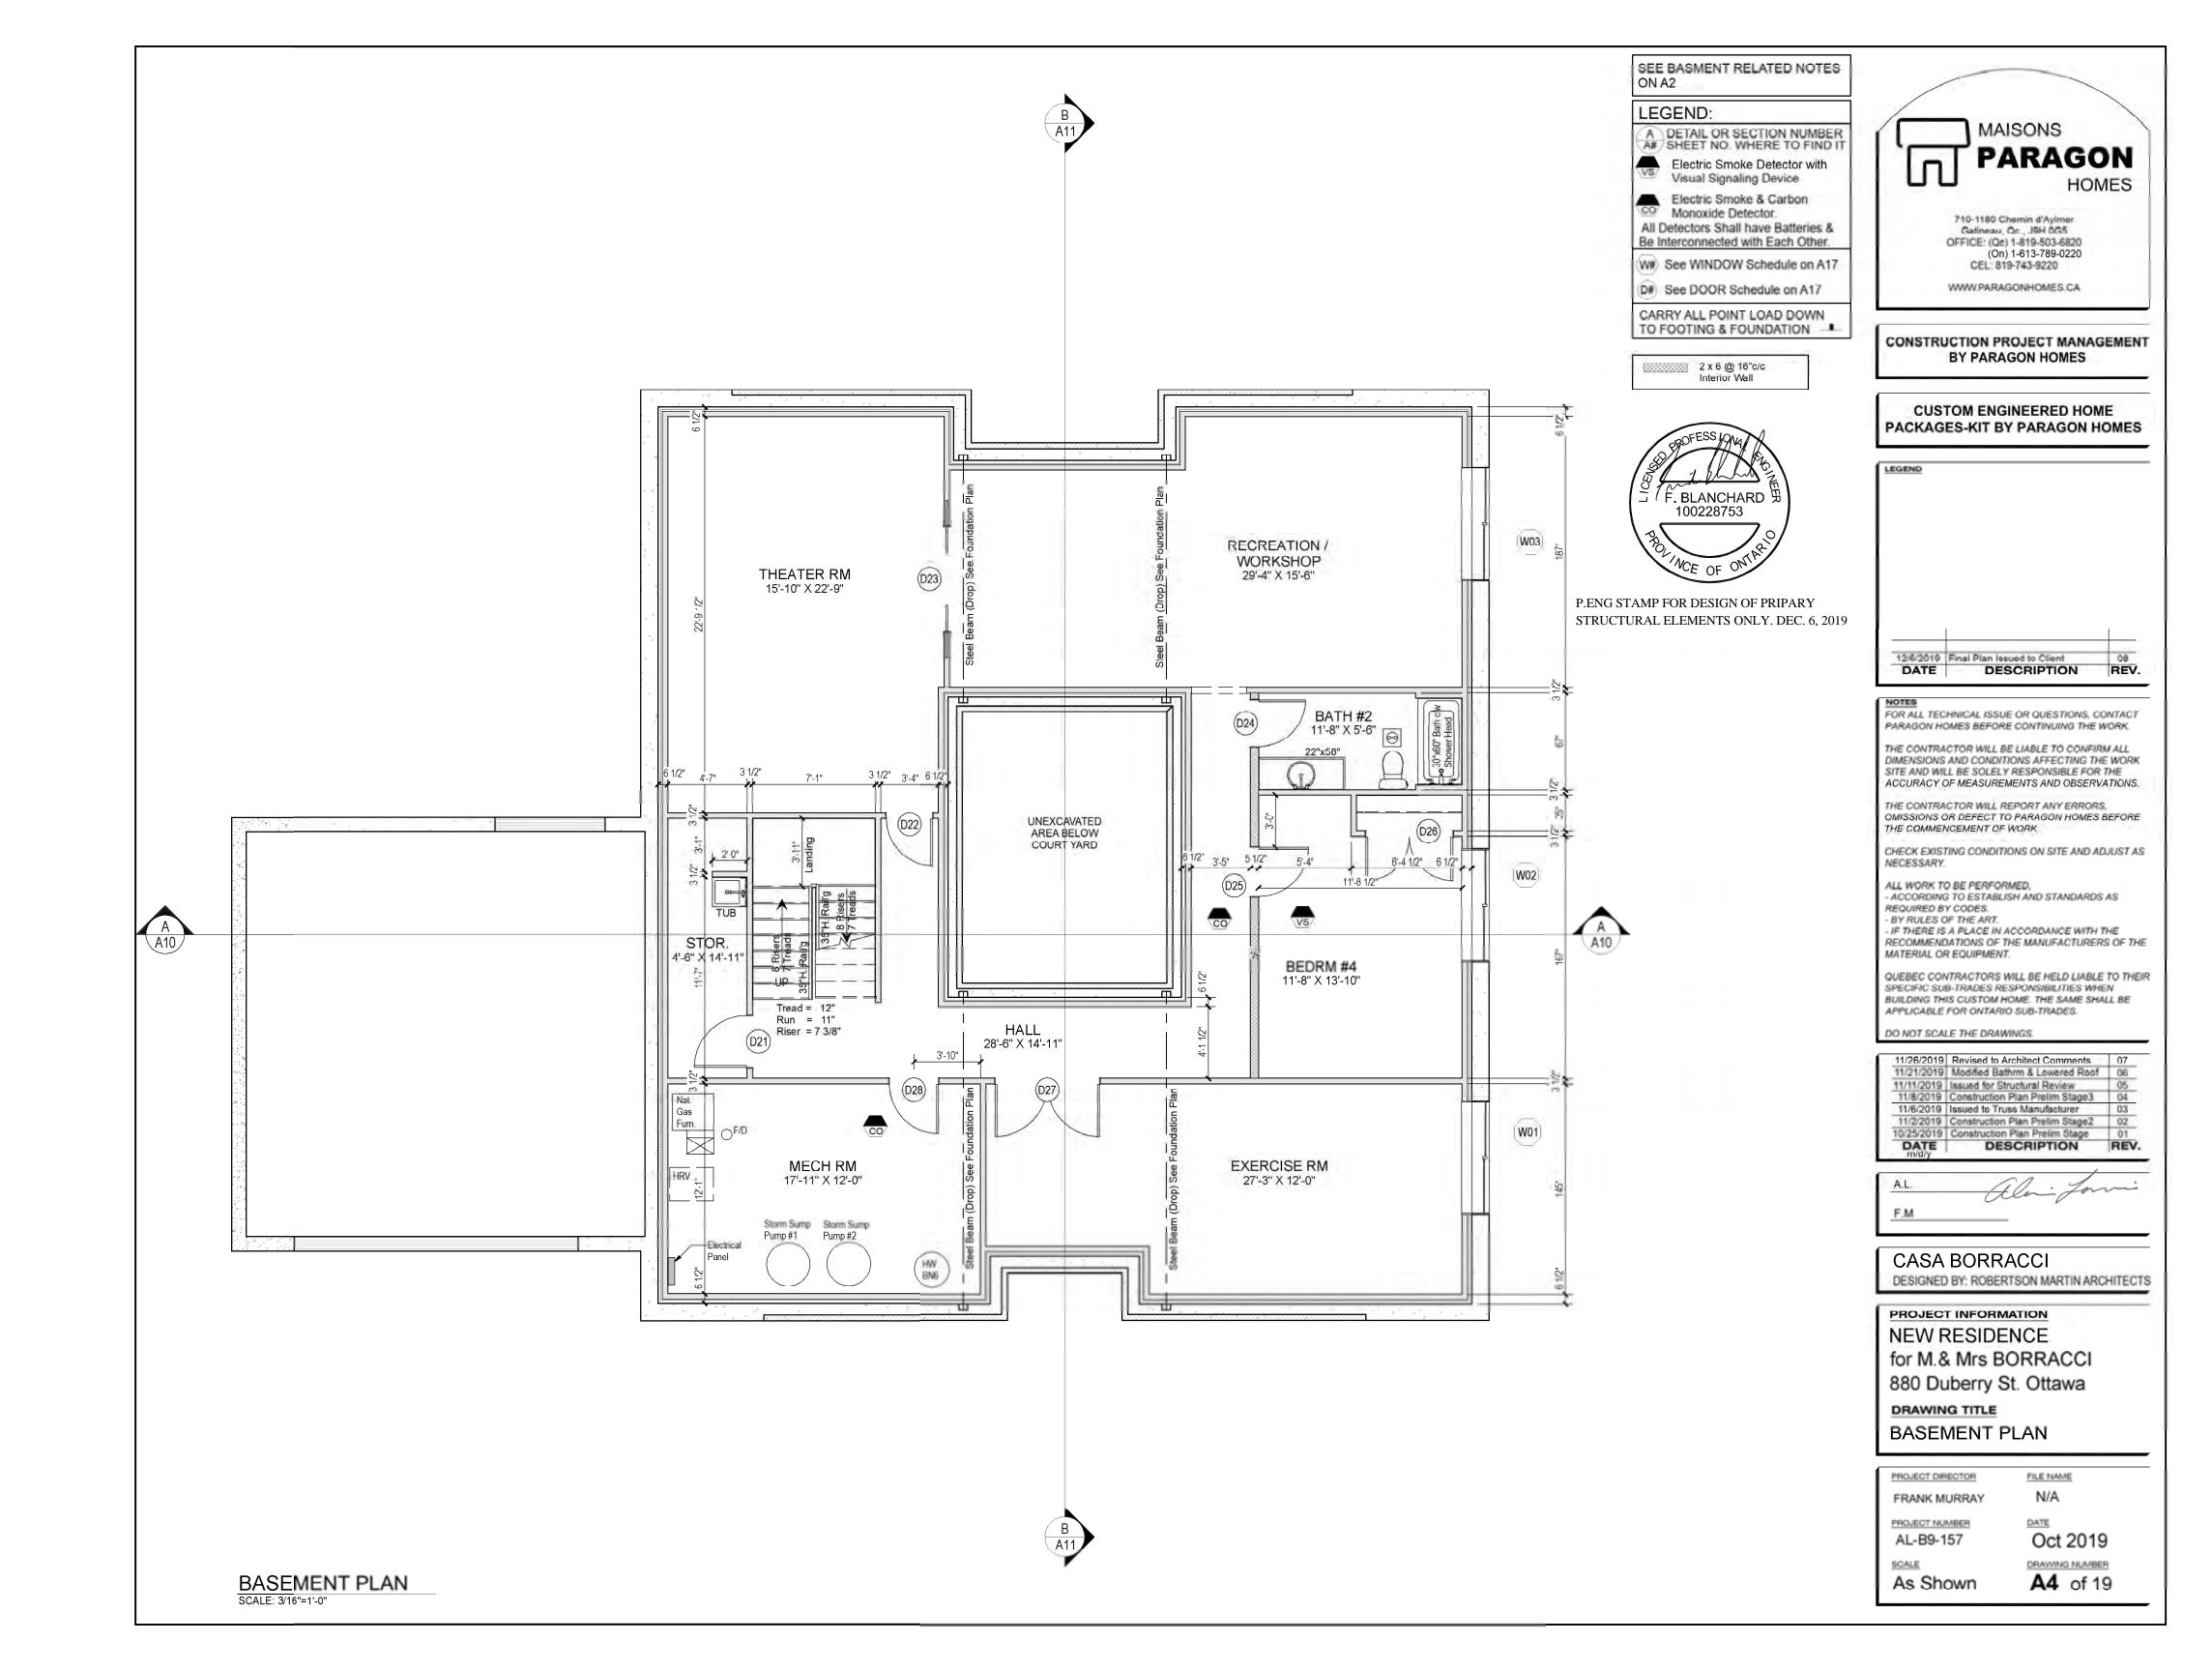

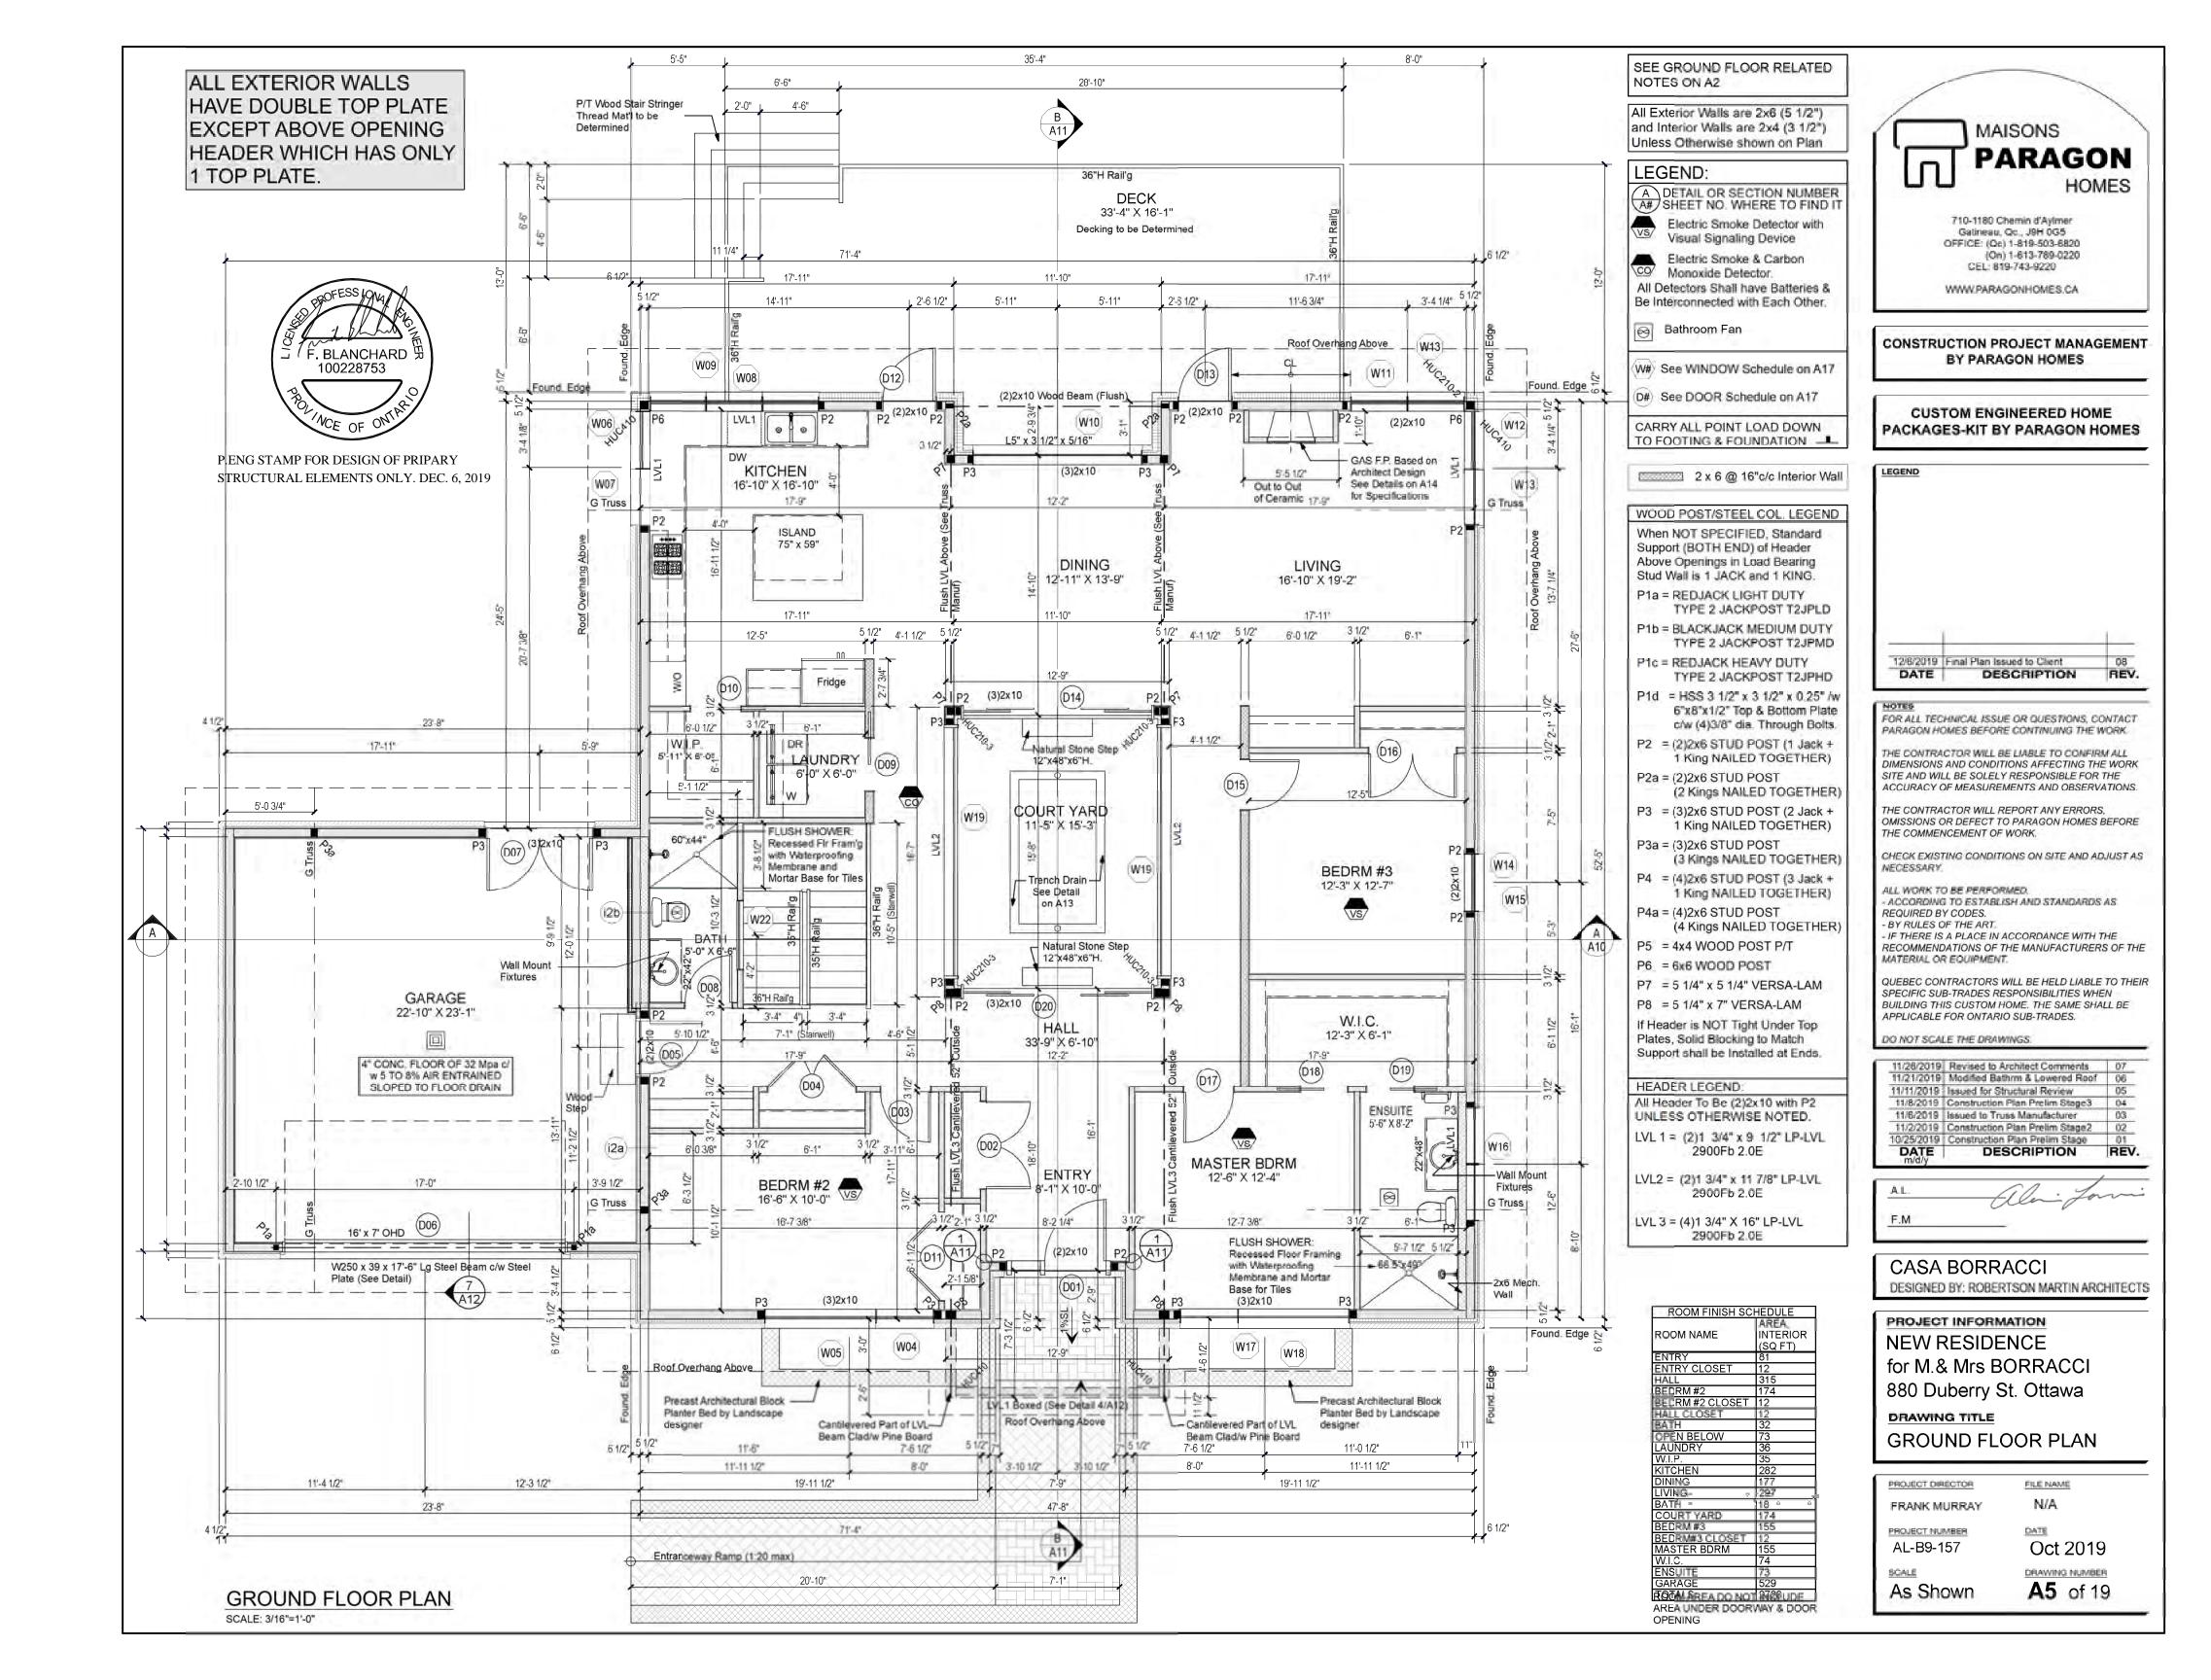


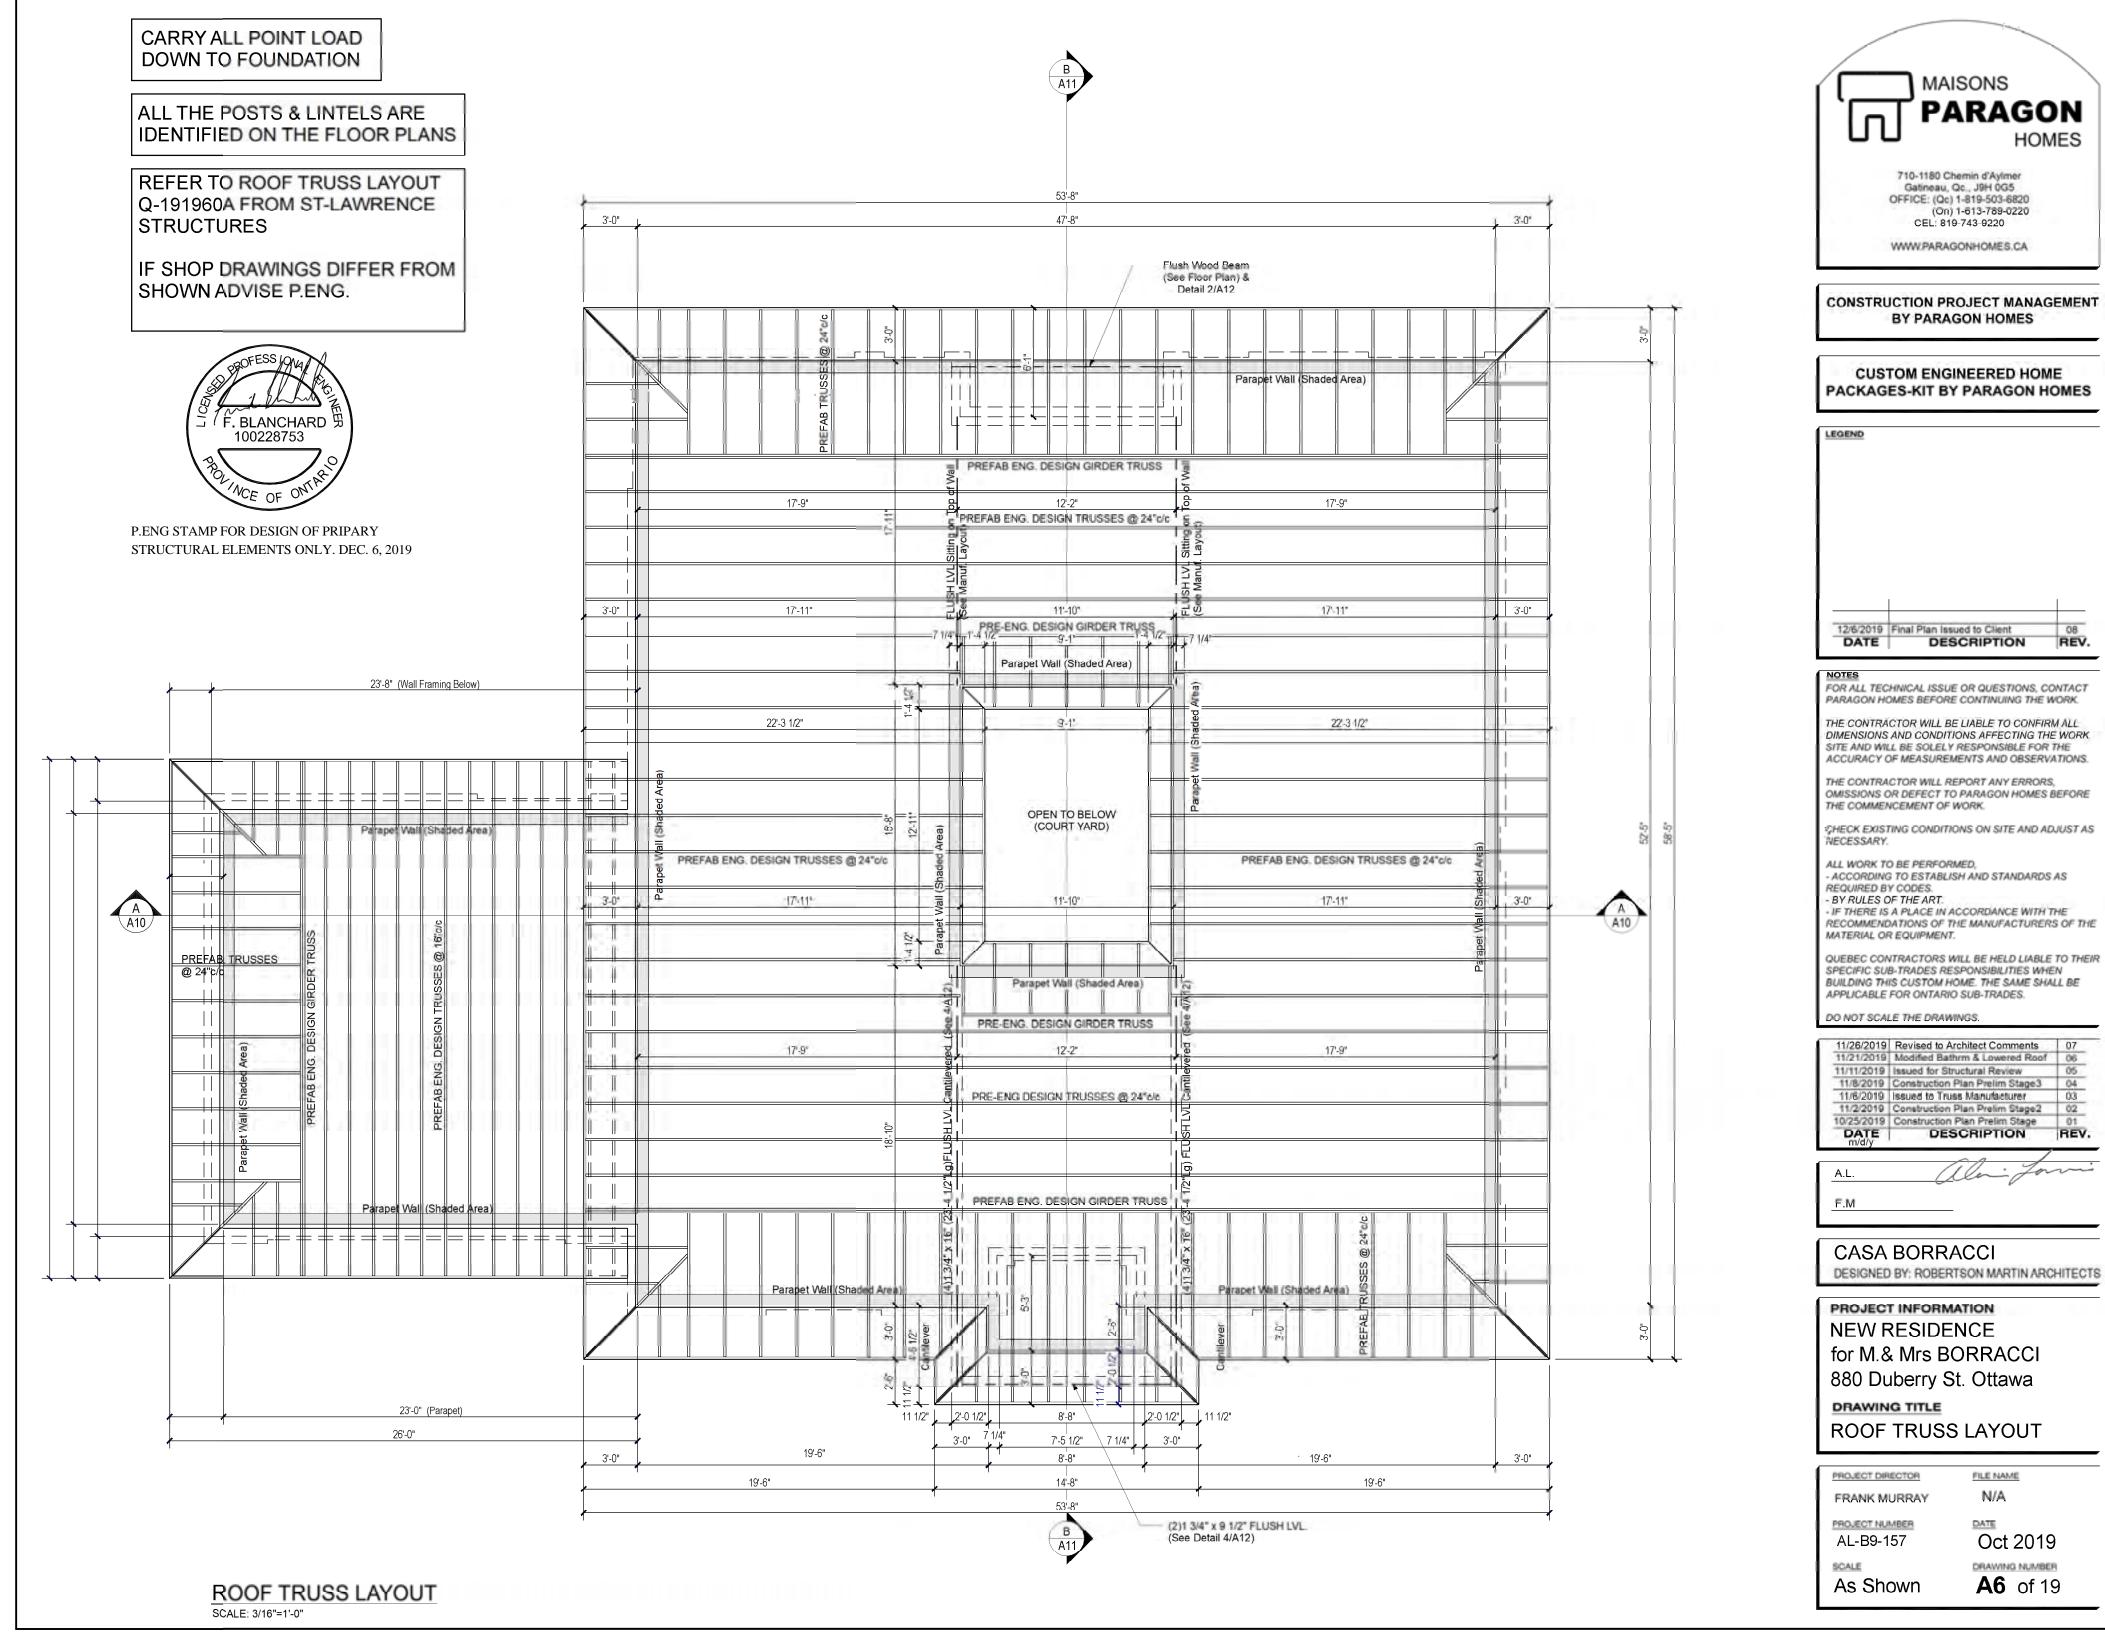





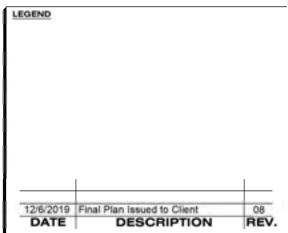


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11/26/2019	Revised to Architect Comments	07

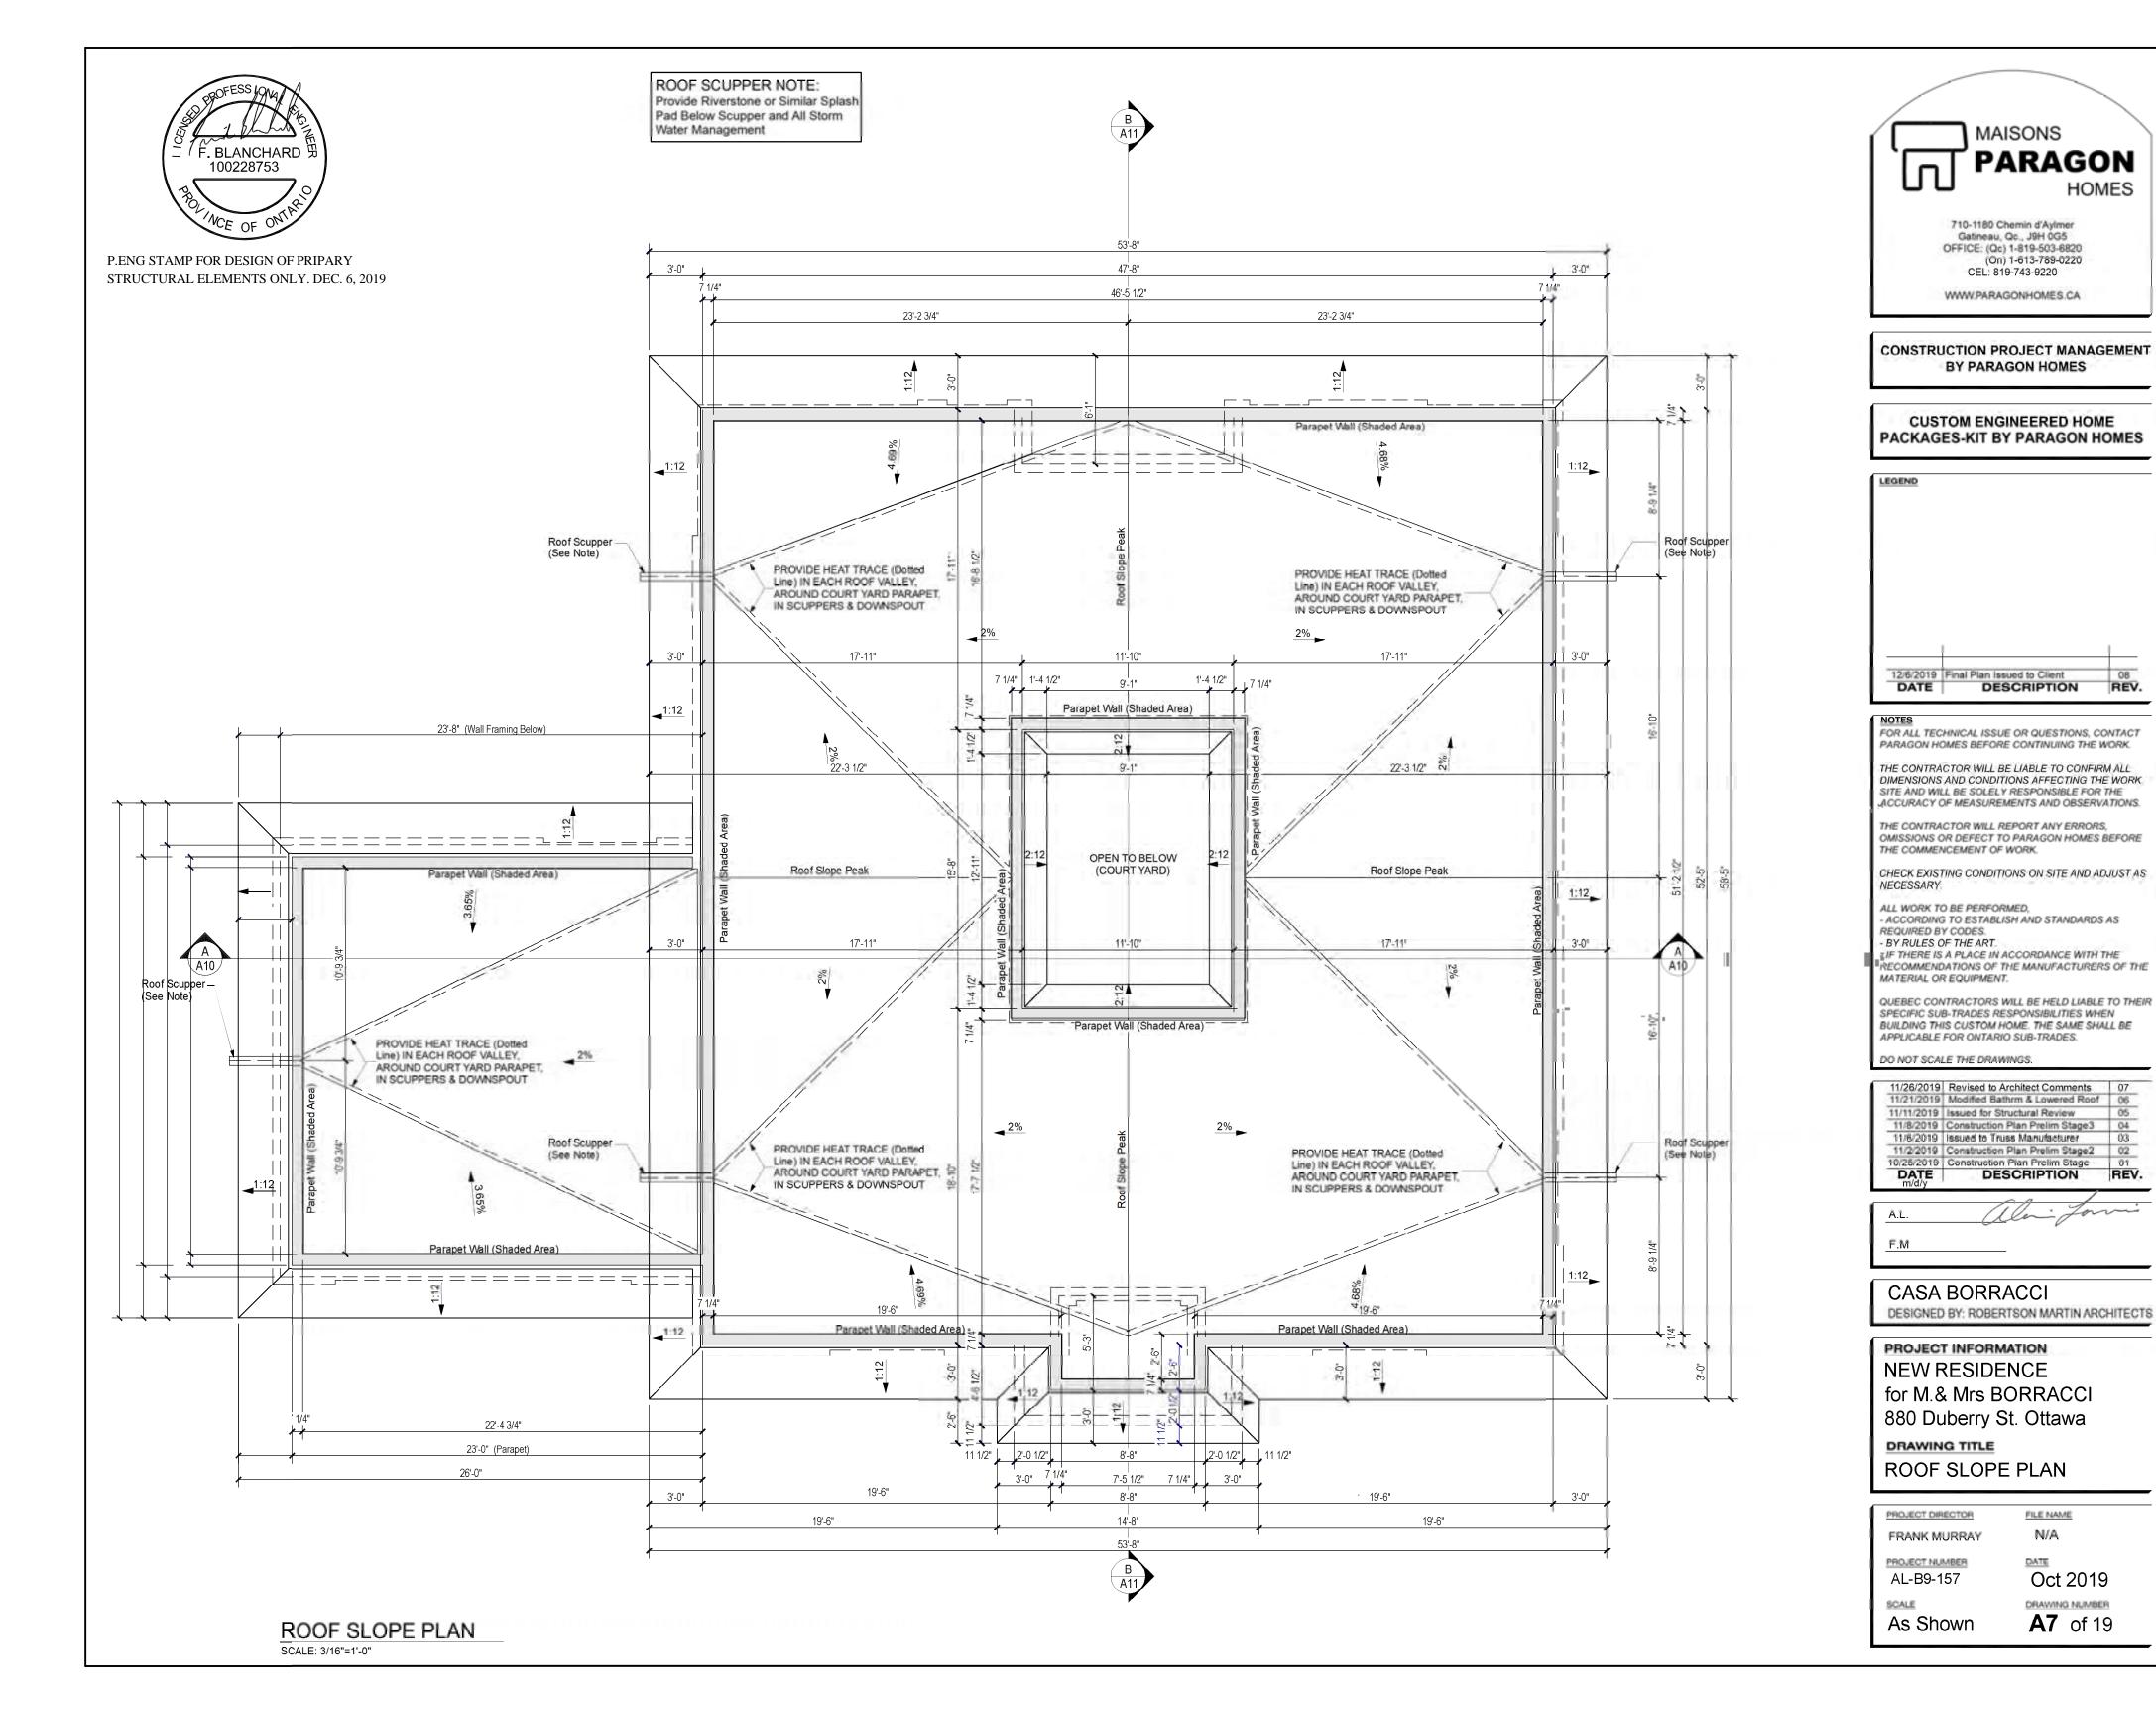

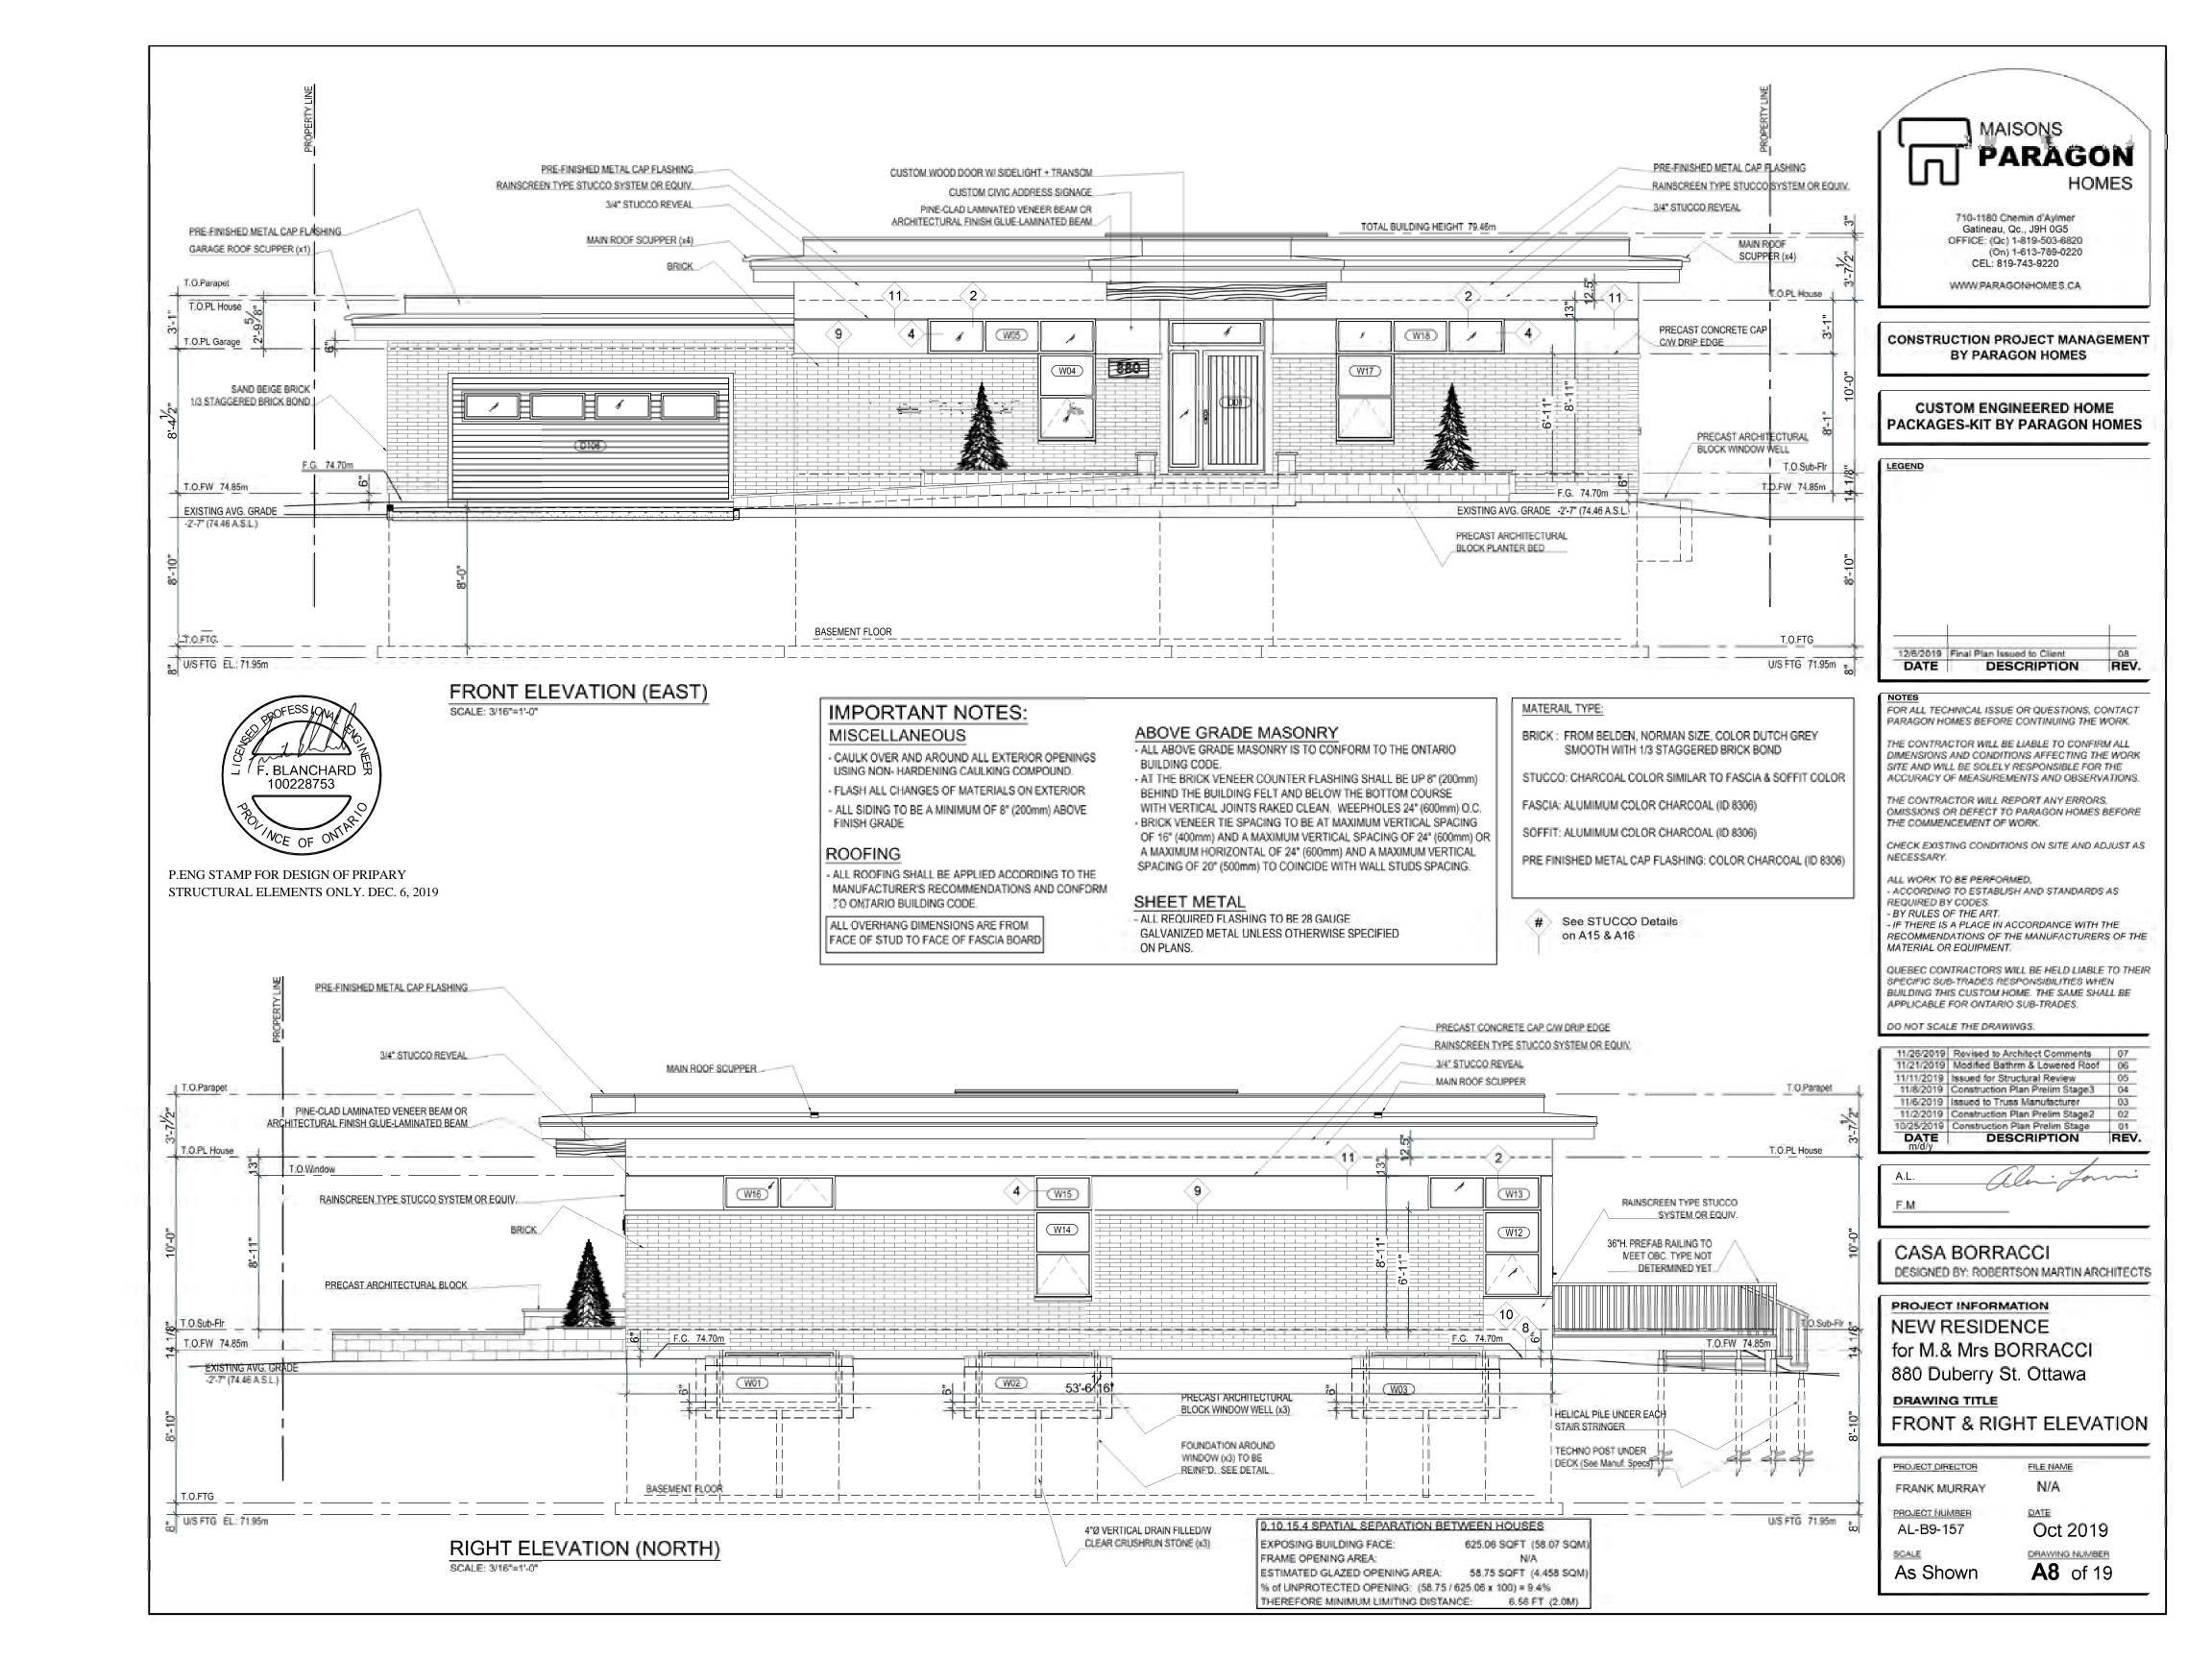

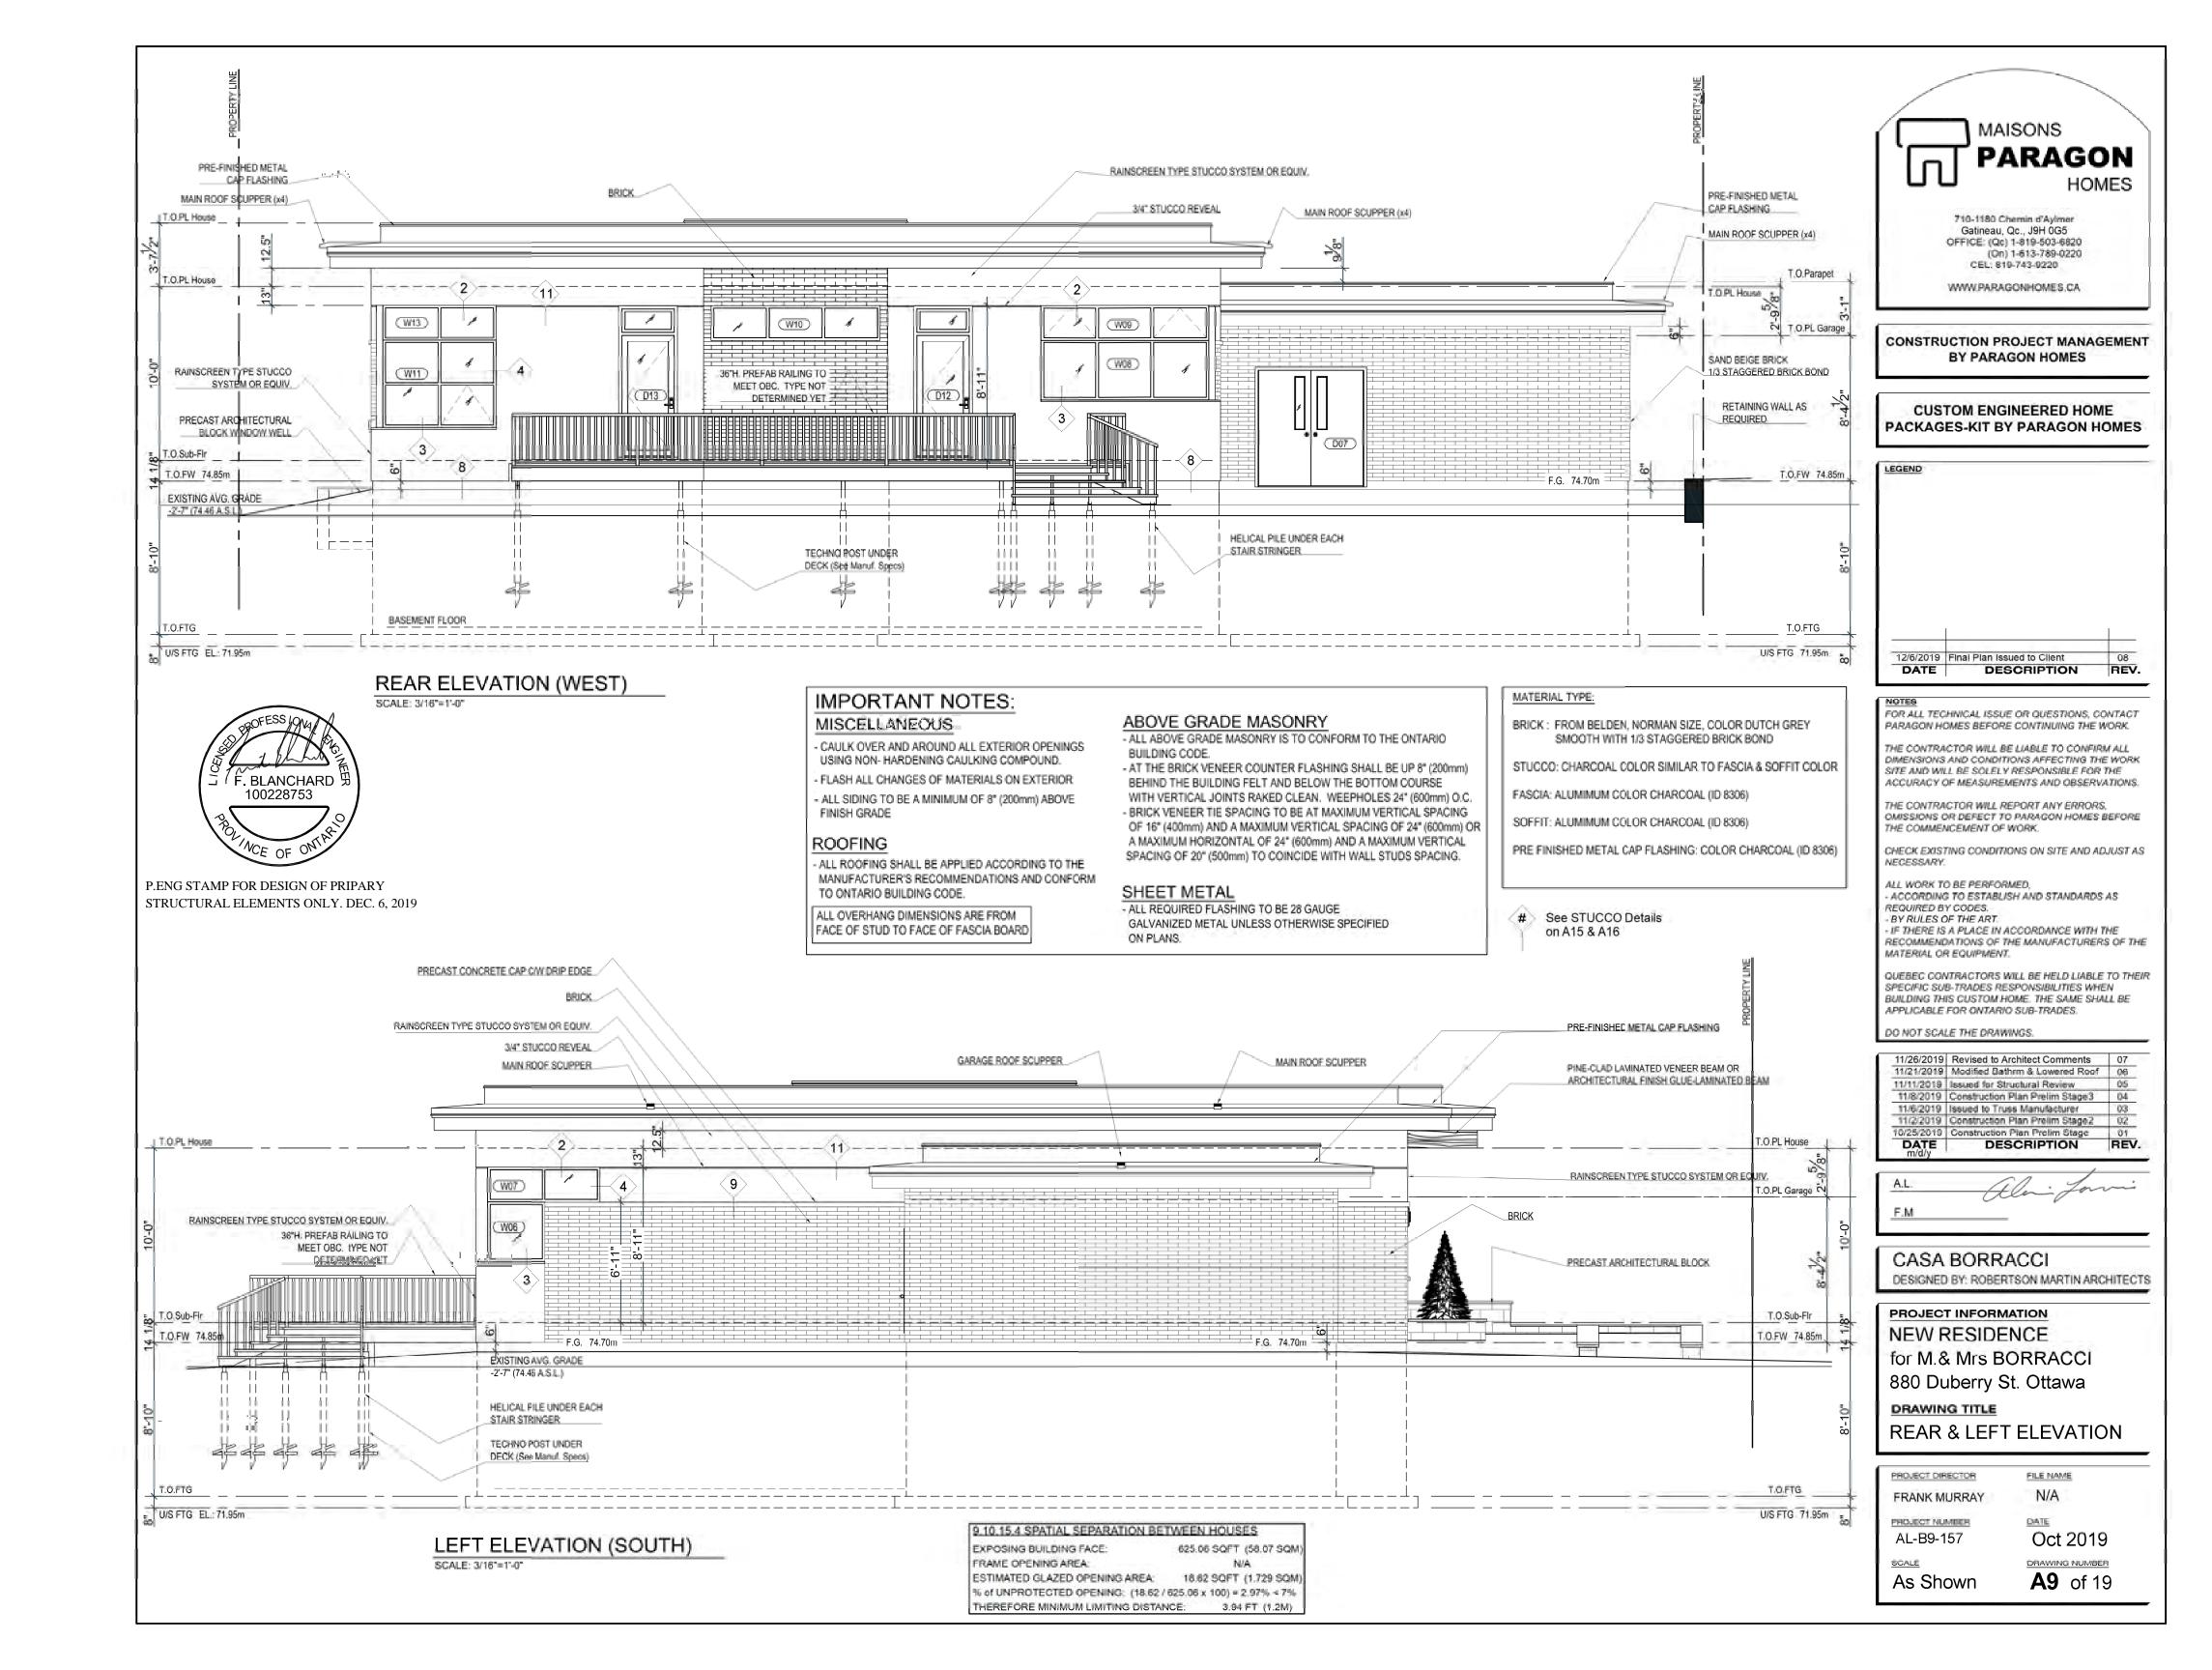

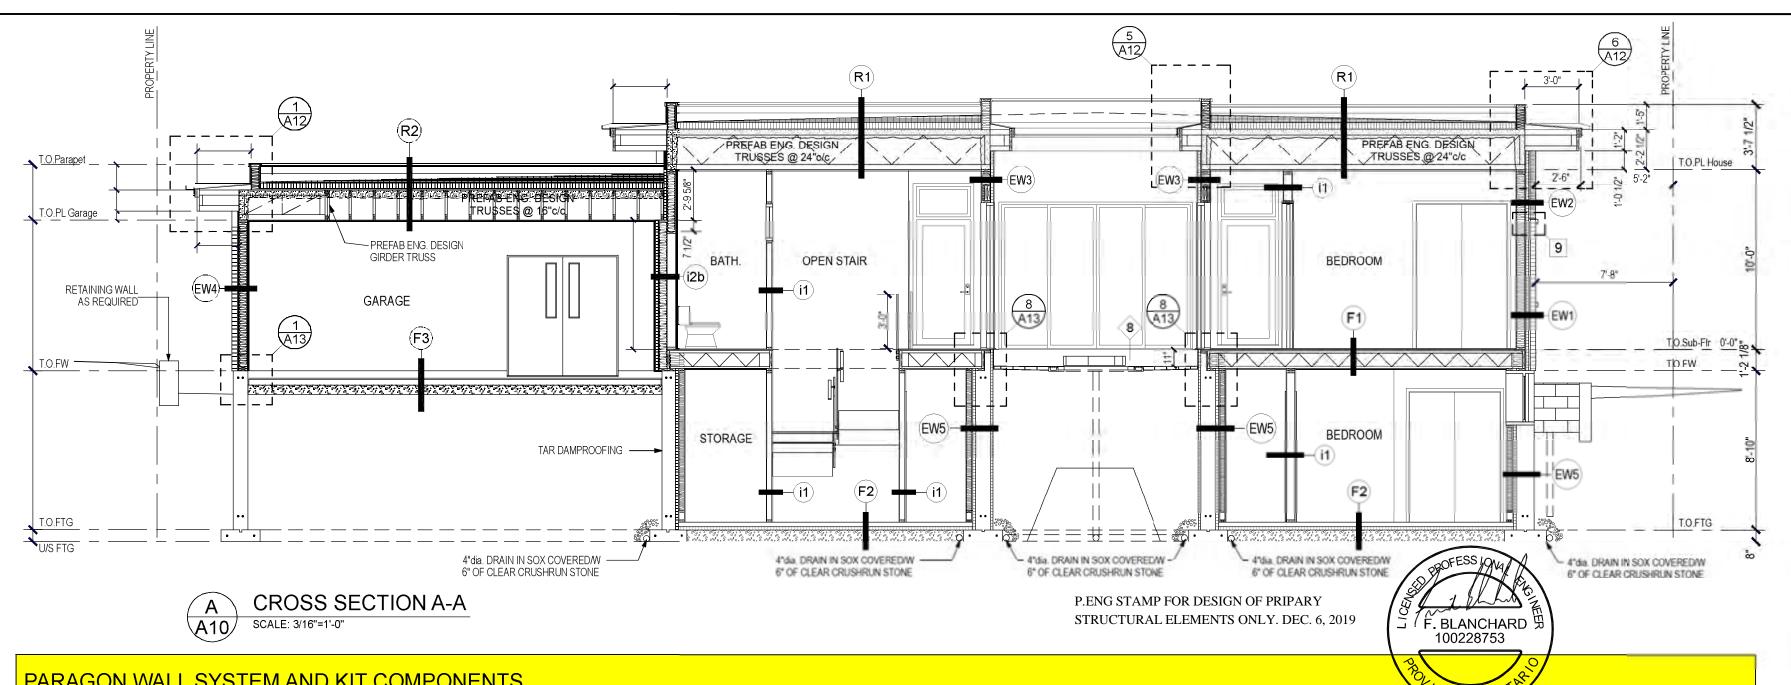

PARAGON WALL SYSTEM AND KIT COMPONENTS

EW-1 EXTERIOR WALL - BRICK

- BRICK (Model & Color See Elevation)
- 1" AIR SPACE
- AIR BARRIER OVERLAPPED MIN. 6" 1 3/4" ISOCLAD (All Joints Sealed and Taped)
- 7/16" OSB SHEATING
- 2 x 6 K/D WOOD STUDS @ 16"c/c
- R22 FIBERGLASS BATT INSULATION
- POLY 6 mil VAPOUR BARRIER #CGSB 51.34M
- (Taped & Sealed Around All Openings) 1 x 3 HORIZONTAL STRAPPING @ 16"c/c
- 1/2" GYPSUM BOARD (Taped and Painted) (Color by Owner)

Total Assembly R-Value: R32 Wall Thickness: 13 7/16"

EW-2 EXTERIOR WALL - EIFS

- EIFS on 4" INSULATION BOARD c/w DRAINAGE GROOVE (Model & Color See Elevation)
- AIR BARRIER OVERLAPPED MIN. 6" 1 3/4" ISOCLAD (All Joints Sealed and Taped)
- 7/16" OSB SHEATING
- 2 x 6 K/D WOOD STUDS @ 16"c/c
- **R22 FIBERGLASS BATT INSULATION**
- (Taped & Sealed Around All Openings)
- 1 x 3 HORIZONTAL STRAPPING @ 16"c/c 1/2" GYPSUM BOARD (Taped and Painted)
- (Color by Owner)

Total Assembly R-Value: R32 Wall Thickness: 13 3/16"

EW-3 EXTERIOR WALL - EIFS HOUSE COURT YARD

- COURT YARD - EIFS on 2" INSULATION BOARD c/w DRAINAGE GROOVE (Model & Color See Elevation) AIR BARRIER OVERLAPPED MIN. 6"

- 7/16" OSB SHEATING
- 2 x 6 K/D WOOD STUDS @ 16"c/c **R22 FIBERGLASS BATT INSULATION**
- POLY 6 mil VAPOUR BARRIER #CGSB 51.34M (Taped & Sealed Around All Openings)
- 1 x 3 HORIZONTAL STRAPPING @ 16"c/c
- 1/2" GYPSUM BOARD (Taped and Painted) (Color by Owner)

Total Assembly R-Value: R22 Wall Thickness: 9 7/16"

EW-4 EXTERIOR WALL - BRICK GARAGE

- BRICK (Model & Color See Elevation)
- 1" AIR SPACE
- AIR BARRIER OVERLAPPED MIN. 6"
- 7/16" OSB SHEATING
- 2 x 6 K/D WOOD STUDS @ 16"c/c - R22 FIBERGLASS BATT INSULATION
- POLY 6 mil VAPOUR BARRIER #CGSB 51.34M (Taped & Sealed Around All Openings)
- 1 x 3 HORIZONTAL STRAPPING @ 16"c/c
- 1/2" GYPSUM BOARD (Taped and Painted) (Color by Owner)

Total Assembly R-Value: R22 Wall Thickness: 11 11/16"

EW-5 EXTERIOR FOUNDATION WAL with FROST WALL

- SAND FINISH (Above Grade)
- PLATON MEMBRANE (Below Grade)
- 1/ 1/2" RIGID INSULATION DOWN TO FOOTING - 25 MPa POURED CONCRETE FOUNDATION WALL
- (Refer to Plan for Wall Thickness)
- 2" (R-10) RIGID INSULATION CODEBOARD - 2 x 4 K/D WOOD STUDS @ 16"c/c
- R-12 FIBERGLASS INSULATION
- (Taped & Sealed Around All Openings) - 1/2" GYPSUM BOARD (Not Taped and Not Painted)

Total Assembly R-Value: R-22 Wall Thickness/w 8" Conc: 14"

I-1 INTERIOR PARTITION WALL (TYP.)

- 1/2" GYPSUM BOARD (Taped & Painted)"
- 2 x 4 K/D WOOD STUDS @ 16"c/c
- 1/2" GYPSUM BOARD (Taped & Painted)** (Color by Owner)
- ALL INTERIOR PARTITIONS TO BE FRAMED WITH
- 2 x 4 UNLESS OTHERWISE NOTED ON PLAN
- ** NOT Taped & Painted in Basement
- *** Strapping to be added when Interior Partition Transition to an Exterior Wall for a Flush Finish

Wall Thickness/w 2x4: 4 1/2" Wall Thickness/w 2x6: 5 1/2*

I-2a GARAGE / HOUSE DIVIDING WALL

- 1/2" GYPSUM BOARD (Taped & Painted)
- (Color as per Owner)
- 1x3 STRAPPING @ 16"c/c
- 1 3/4" ISOCLAD (All Joints Sealed and Taped) - 2 x 6 K/D WOOD STUDS @ 16"c/c (Furred Wall)
- R-22 FIBER GLASS BATT INSULATION
- POLY. 6 mil VAPOUR BARRIER #CGSB 51.34M
- (Taped & Sealed Around All Openings)

- 2 x 6 K/D WOOD STUDS @ 16"c/c (Bearing Wall) 1/2" GYPSUM BOARD (Taped and Painted)
- (Color as per Owner)

Total Assembly R-Value: R32 Wall Thickness. 9 15/16

I-2b GARAGE / HOUSE DIVIDING WALL

- 1/2" GYPSUM BOARD (Taped & Painted)
- (Color as per Owner) - 1x3 STRAPPING @ 16"c/c

Unless Otherwise Noted.

- 1 3/4" ISOCLAD (All Joints Sealed and Taped)
- 2 x 6 K/D WOOD STUDS @ 16"c/c
- R-22 FIBER GLASS BATT INSULATION
- POLY, 6 mil VAPOUR BARRIER #CGSB 51.34M (Taped & Sealed Around All Openings)

1/2" GYPSUM BOARD (Taped and Painted)

(Color as per Owner) * LOAD BEARING WALL IF MENTIONED ON PLANS

are to be Framed/w 2 x 6 @ 16°c/c SPF No1/No2

THE PROJECT MANAGER AND FRAMER SHALL BE RESPONSIBLE OF THE EXACT PLACING OF THE WALL IN RELATION WITH THE PLANS AND THE ACTUAL SITE CONDITIONS. ANY OMISSIONS SHALL BE RESOLVED BY GENERAL CONTRACTOR, ALL DIFFERENT MATERIAL JUNCTIONS ARE TO BE PROPERLY

AULKING & FLASHING TO SUIT SITE CONDITIONS.

ALL MATERIAL CAN BE CHANGED WITHOUT NOTICE FOR AN EQUIVALENT PRODUCT WITH THE SAME QUALITY, AND ALL MATERIAL SHALL BE INSTALLED IN STRICT CONFORMANCE WITH MANUFACTURE'S

F-1 FLOOR (FIRST STOREY)

- FINISH FLOORING (As per Owner) - 3/4" T/G OSE EDGE GOLD (Glued & Nailed)
- 11 7/8" TJI JOISTS (Main Floor) (Refer to Manufacturer's Shop Drawings)

F-2 CONCRETE SLAB (HOUSE)

- FINISH FLOORING (As per Owner)
- 3" CONCRETE SLAB (20 MPa) (Buffed) - 2" (R10) RIGID INSULATION
- 6 Mil POLY, VAPOR BARRIER #CGSB 51.34M
- 8" of CRUSH RUN STONE
- UNDISTURBED NATIVE SOIL

F-3 CONCRETE SLAB (GARAGE)

- 4" CONCRETE SLAB of 32 MPa c/w 5 to 8%
- AIR ENTRAINED 6 Mil POLY, VAPOR BARRIER #CGSB 51.34M
- 6" of CRUSH RUN STONE
- SAND BACKFILLED COMPACTED TO 95% MODIFIED PROCTOR IN BETWEEN EACH
- 12" OF LIFT. - UNDISTURBED NATIVE SOIL

R-1 ROOF (HOUSE) R50

- 2 PLY MODIFIED BITUMEN ROOFING SYSTEM. USING SELF-ADHERING BASE SHEET AND A TORCH APPLIED CAP SHEET WITH A GRANULE SURFACE
- 4" (R20) RIGID INSULATION
- PRE-ENGINEERED ROOF TRUSSES

- 6 Mil POLY, VAPOUR BARRIER #CGSB 51:34M
- 1/2" GYPSUM BOARD (Taped and Painted) (Color as per Owner)
- 2 PLY MODIFIED BITUMEN ROOFING SYSTEM. USING SELF-ADHERING BASE SHEET AND A TORCH APPLIED CAP SHEET WITH A GRANULE
- SLOPED RIGID INSULATION FOR 2% SLOPE

- (See Manuf, Plan)
- UNDER ROOF PLYWOOD
- 1 x 3 STRAPPING @ 24°c/c
- 1/2" GYPSUM BOARD (Taped and Painted) (Color as per Owner)



- Vapour Barrier
- 4. 2" X 6" KD Studs
- 5. R-22 Fiberglass Insulation
- 6. OSB cladding 7/16" 7. 1-3/4" Isoclad sheathing (R 7.5)
- 8. Exterior 1" X 3" Furring

Total R-Value of Wall: R-32

Superior than Building Code, EnergySTAR & Novoclimat!

- SLOPED RIGID INSULATION FOR 2% SLOPE
- 3/4" PLYWOOD
- (See Manuf. Plan)
- R30 CLOSED CELL SPRAYFOAM INSULATION UNDER ROOF PLYWOOD
- (Taped and Sealed) - 1 x 3 STRAPPING @ 24"c/c

R-2 ROOF (GARAGE) R32

- SURFACE
- 4" (R20) RIGID INSULATION
- 5/8" T&G PLYWOOD PRE-ENGINEERED ROOF TRUSSES
- R12 CLOSE CELL SPRAYFOAM INSULATION
- 6 Mil POLY, VAPOUR BARRIER #CGSB 51.34M (Taped and Sealed)



R-32 Wall System

CASA BORRACCI DESIGNED BY: ROBERTSON MARTIN ARCHITECTS

A.L.

F.M

PROJECT INFORMATION NEW RESIDENCE for M.& Mrs BORRACCI 880 Duberry St. Ottawa

DRAWING TITLE

CROSS SECTION A-A

PROJECT DIRECTOR

FILE NAME

MAISONS

710-1180 Chemin d'Aylmer

Gatineau, Qc., J9H 0G5

OFFICE: (Qc) 1-819-503-6820 (On) 1-613-789-0220 CEL: 819-743-9220

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CONSTRUCTION PROJECT MANAGEMENT

BY PARAGON HOMES

CUSTOM ENGINEERED HOME PACKAGES-KIT BY PARAGON HOMES

12/6/2019 Final Plan Issued to Client

DESCRIPTION

FOR ALL TECHNICAL ISSUE OR QUESTIONS, CONTACT PARAGON HOMES BEFORE CONTINUING THE WORK.

THE CONTRACTOR WILL BE LIABLE TO CONFIRM ALL

SITE AND WILL BE SOLELY RESPONSIBLE FOR THE

THE CONTRACTOR WILL REPORT ANY ERRORS,

THE COMMENCEMENT OF WORK.

ALL WORK TO BE PERFORMED.

REQUIRED BY CODES.

- BY RULES OF THE ART.

MATERIAL OR EQUIPMENT.

DIMENSIONS AND CONDITIONS AFFECTING THE WORK

ACCURACY OF MEASUREMENTS AND OBSERVATIONS

OMISSIONS OR DEFECT TO PARAGON HOMES BEFORE

CHECK EXISTING CONDITIONS ON SITE AND ADJUST AS

- ACCORDING TO ESTABLISH AND STANDARDS AS

IF THERE IS A PLACE IN ACCORDANCE WITH THE

SPECIFIC SUB-TRADES RESPONSIBILITIES WHEN BUILDING THIS CUSTOM HOME, THE SAME SHALL BE

APPLICABLE FOR ONTARIO SUB-TRADES.

11/11/2019 Issued for Structural Review

11/6/2019 Issued to Truss Manufacturer

11/8/2019 | Construction Plan Prelim Stage3

11/2/2019 Construction Plan Prelim Stage2

10/25/2019 | Construction Plan Prelim Stage

DO NOT SCALE THE DRAWINGS.

RECOMMENDATIONS OF THE MANUFACTURERS OF THE

QUEBEC CONTRACTORS WILL BE HELD LIABLE TO THEIR

Revised to Architect Comments

DESCRIPTION

11/21/2019 Modified Bathrm & Lowered Roof 06

REV.

LEGEND

PARAGON

HOMES


FRANK MURRAY PROJECT NUMBER


DATE AL-B9-157 Oct 2019


SCALE As Shown


DRAWING NUMBER A10 of 19

N/A

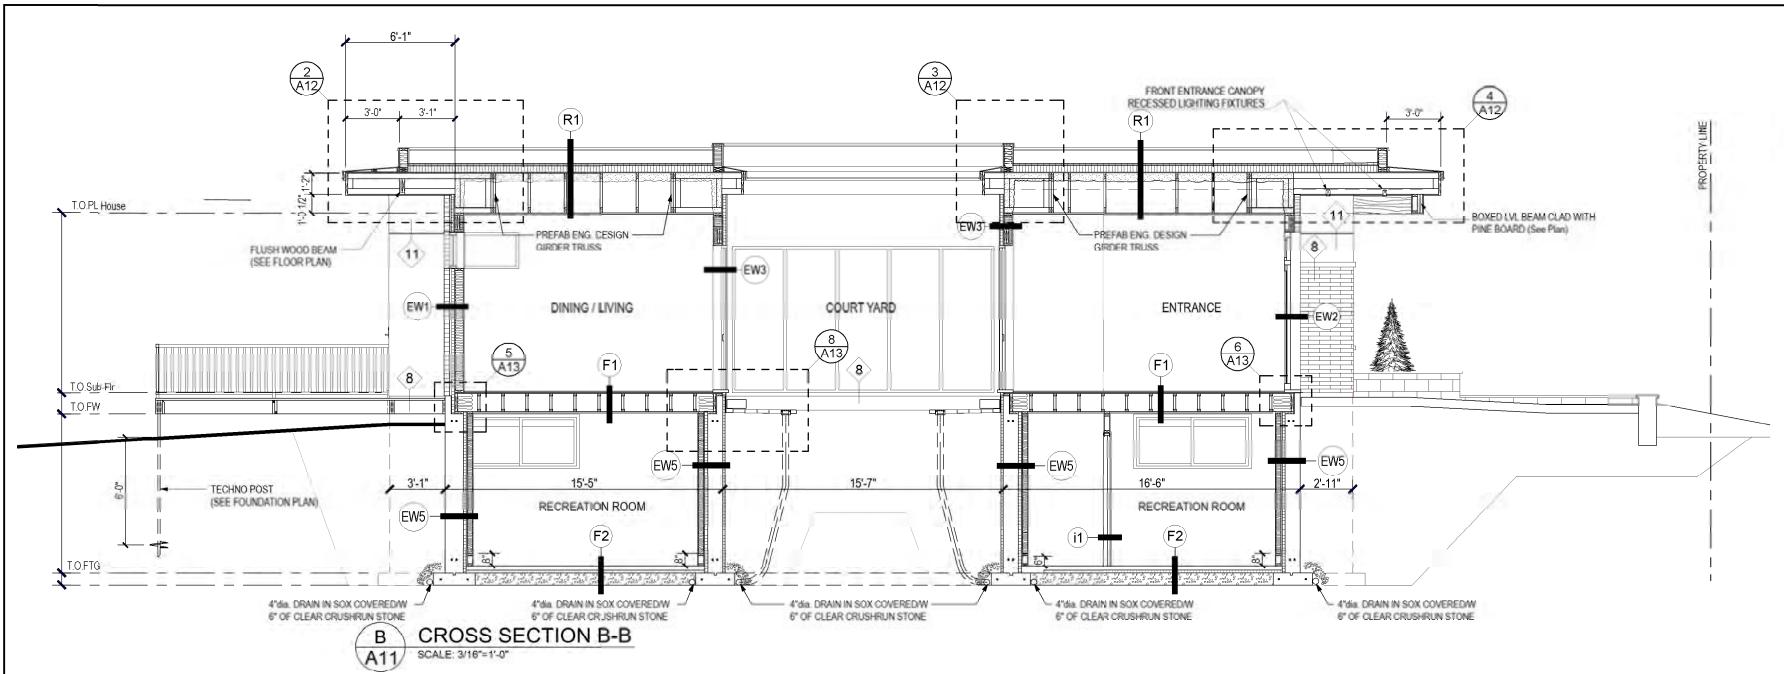

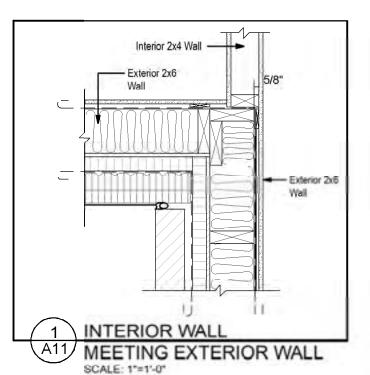

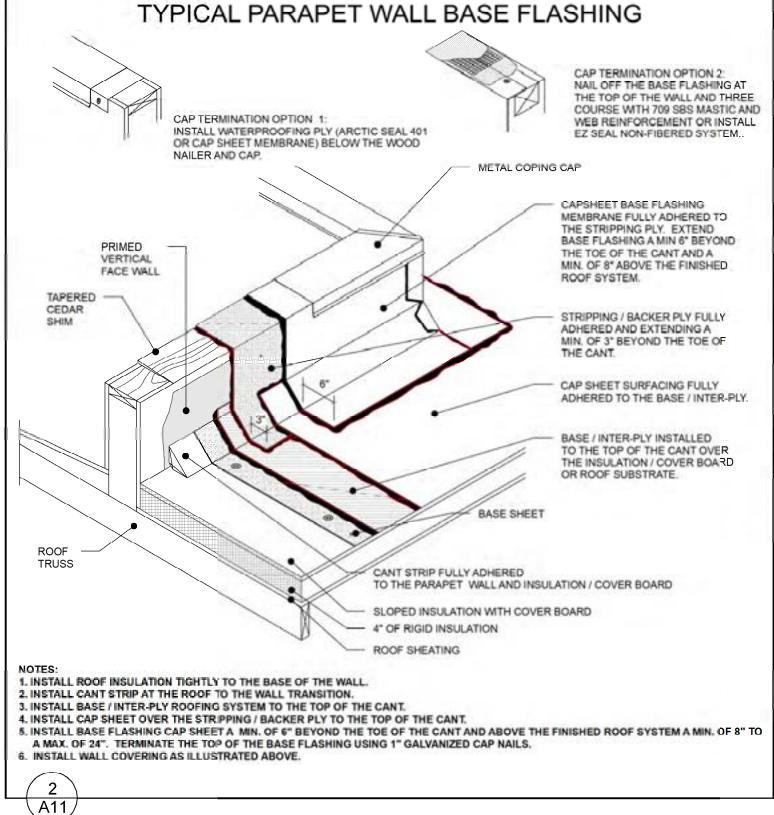


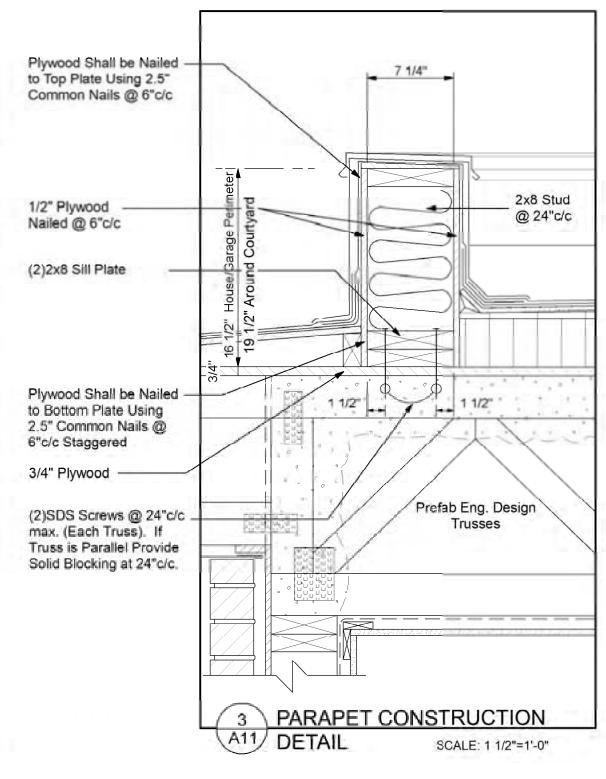



CONSTRUCTION PROJECT MANAGEMENT BY PARAGON HOMES

CUSTOM ENGINEERED HOME PACKAGES-KIT BY PARAGON HOMES

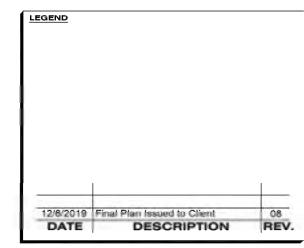

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DATE m/d/y	DESCRIPTION	REV
A STATE OF THE STA	Construction Plan Prelim Stage	01
	Construction Plan Prelim Stage2	02
	Issued to Truss Manufacturer	0.3
	Construction Plan Prelim Stage3	04
	Issued for Structural Review	05
minutes out on the four at the rack	Modified Bathrm & Lowered Roof	06
	Revised to Architect Comments	07

AL. ala: Jan.

CASA BORRACCI

DESIGNED BY: ROBERTSON MARTIN ARCHITECTS

PROJECT INFORMATION
NEW RESIDENCE
for M.& Mrs BORRACCI
880 Duberry St. Ottawa
PRAWING TITLE
CROSS SECTION B-B

FRANK MURRAY

FRANK MURRAY

PROJECT NUMBER

AL-B9-157


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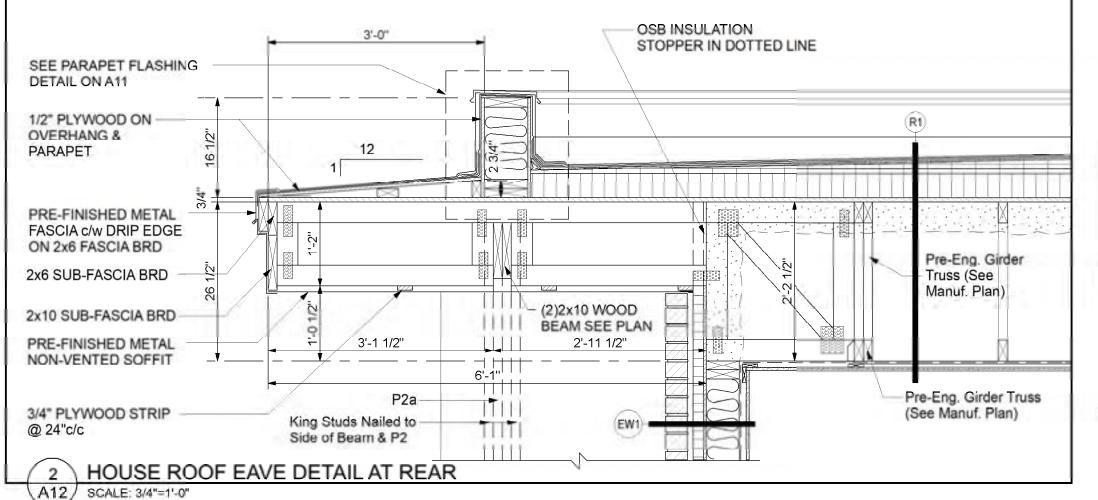
AS Shown

A11 of 19





P.ENG STAMP FOR DESIGN OF PRIPARY STRUCTURAL ELEMENTS ONLY. DEC. 6, 2019




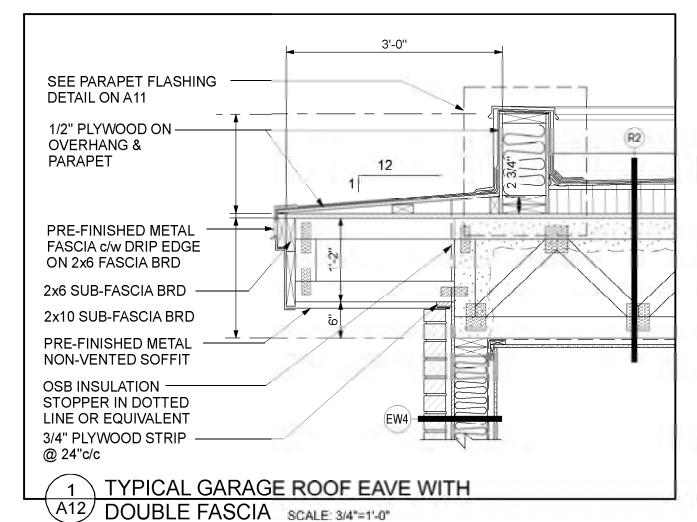


16 1/2" SEE PARAPET FLASHING **DETAIL ON A11** 1/2" PLYWOOD ON **OVERHANG &** PARAPET PRE-FINISHED METAL -FASCIA c/w DRIP EDGE ON 2x6 FASCIA BRD 2x6 SUB-FASCIA BRD 2x10 SUB-FASCIA BRD-16 1/2" PRE-FINISHED METAL NON-VENTED SOFFIT INSTALL 1 3/4' ISOCLAD (Dotted — Line) IN BETWEEN TRUSSES. Pre-Eng. Girder FILL GAPS WITH SPRAY FOAM Truss (See Manuf. IF ANY. Plan) 3/4" PLYWOOD STRIP 3 HOUSE (COURT YARD) A12 ROOF EAVE DETAIL SCALE: 3/4"=1'-0"

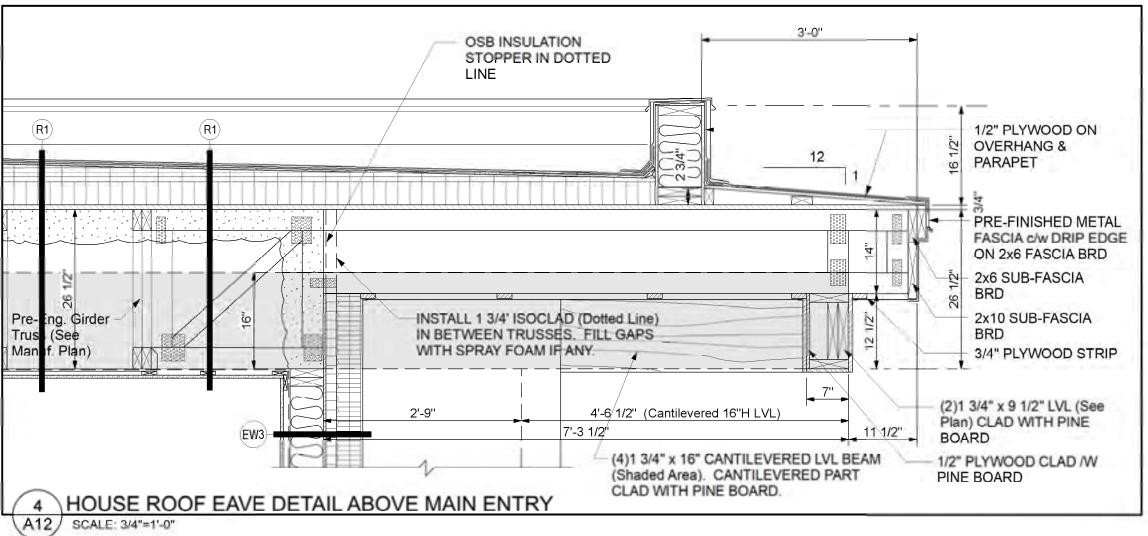

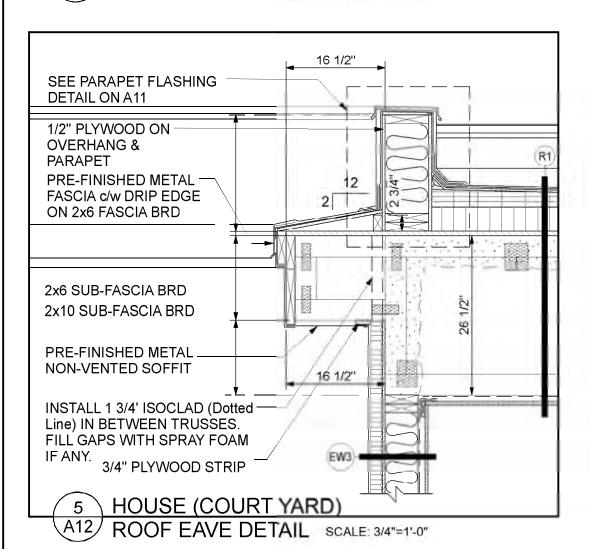

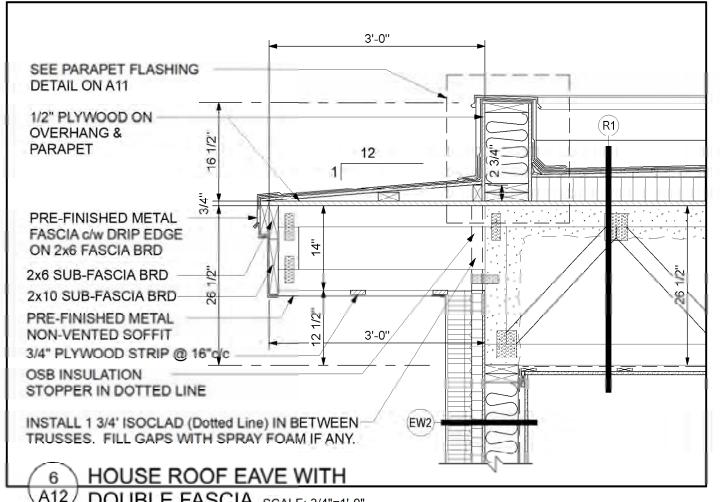

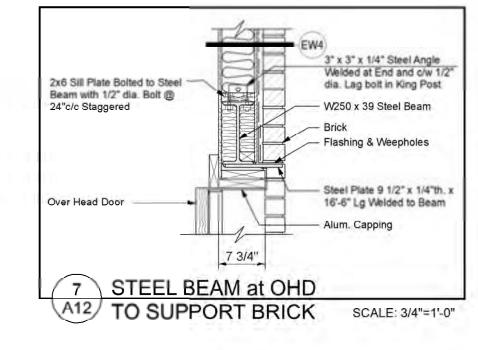


SEE PARAPET STRUCTURAL DETAIL 3/A11



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DATE	DESCRIPTION	REV
10/25/2019		01
11/2/2019	Construction Plan Prelim Stage2	02
	Issued to Truss Manufacturer	03
	Construction Plan Prelim Stage3	04
11/11/2019	Issued for Structural Review	05
11/21/2019	Modified Bathrm & Lowered Roof	06
	Revised to Architect Comments	07

F.M

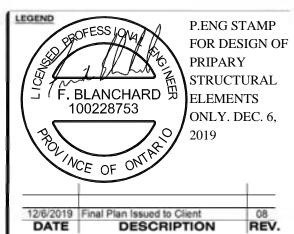CASA BORRACCI

DESIGNED BY: ROBERTSON MARTIN ARCHITECTS

PROJECT INFORMATION **NEW RESIDENCE** for M.& Mrs BORRACCI 880 Duberry St. Ottawa DRAWING TITLE CONSTRUCTION DETAIL


PROJECT DIRECTOR FRANK MURRAY FILE NAME N/A

PROJECT NUMBER AL-B9-157

Oct 2019

DRAWING NUMBER **A12** of 19 As Shown

A12 DOUBLE FASCIA SCALE: 3/4"=1'-0"

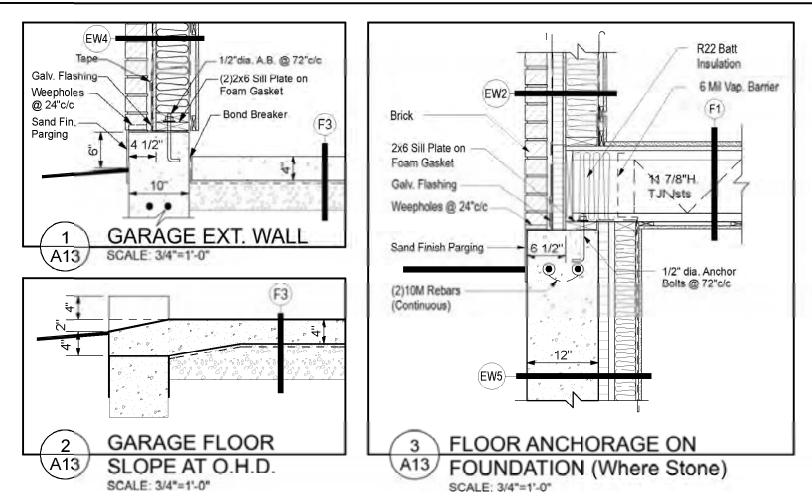

Peal & Stick

Caulking

Membrane Under Sill

Sand Finish Parging

- Air Barrier Wrap from

U/S Sill Plate to U/S

of Door Sill

·12"

FOUNDATION CURB DETAIL

A13 (Main Entry) SCALE: 3/4"=1'-0"

Interlock Pavers

R22 Batt

Insulation

6 Mil Vap. Barner

2x6 Sill Plate on

1/2" dia Anchor

Bolts @ 72°c/c


(2)10M Rebars

(Continuous)


Foam Gasket

11 7/8"H.

TJI Jsts

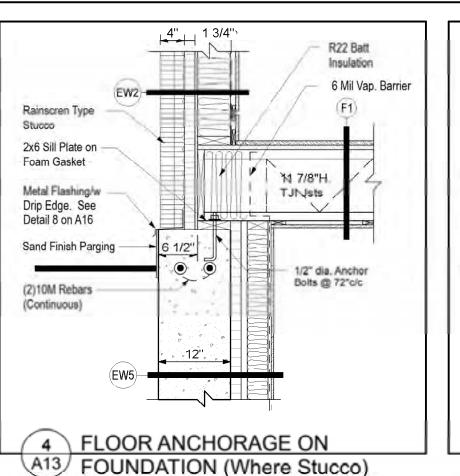

SCALE: 3/4"=1'-0"

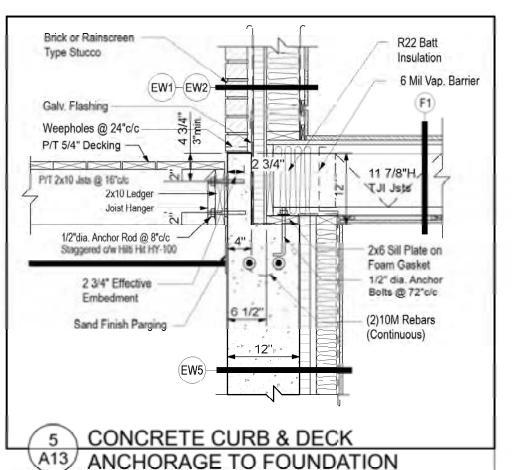

CUSTOM ENGINEERED HOME PACKAGES-KIT BY PARAGON HOMES

MAISONS

710-1180 Chemin d'Aylmer

Gatineau, Qc., J9H 0G5

OFFICE: (Qc) 1-819-503-6820

CEL: 819-743-9220

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CONSTRUCTION PROJECT MANAGEMENT BY PARAGON HOMES

(On) 1-613-789-0220

PARAGON

HOMES

LEGEND 12/8/2019 Final Plan Issued to Clien DATE DESCRIPTION REV.

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F.M

CASA BORRACCI

DESIGNED BY: ROBERTSON MARTIN ARCHITECTS

PROJECT INFORMATION NEW RESIDENCE for M.& Mrs BORRACCI 880 Duberry St. Ottawa DRAWING TITLE

CONSTRUCTION DETAIL PROJECT DIRECTOR FILE NAME

> PROJECT NUMBER AL-B9-157

FRANK MURRAY

As Shown

Oct 2019 DRAWING NUMBER **A13** of 19

N/A

R22 Batt Insulation 6 Mil Vap. Barrier Weepholes @ 24"c/c Main Entry Planter 11 7/8"H. S TJI Jsts 4" lopsoil 2x6 Sill Plate on Foam Gasket Air Barrier Wrap from 1/2" dia. Anchor U/S Sill Plate to U/S Bolts @ 72°c/c of Door Sill (2)10M Rebars (Continuous)


FOUNDATION CURB DETAIL

(Main Entry Planter) SCALE: 3/4"=1'-0"


2x4 Sill Plate on Foam Gasket 1/2" dia. Anchor Bolts @ 72"c/c -Air Barrier Wrap from U/S Sill Plate to U/S of Door Sill Peal & Stick Membrane Under Sill R22 Batt Insulation 6 Mil Vap. Barrier Sand Finish Parging HEAT TRACE SYSTEM AT PATHWAY PERIMETER on 1/2" Ciment Brd ACO TRENCH / SLAB DRAIN (H100-8 CHANNEL SYSTEM) HEAT TRACE WITHIN DRAIN 11 7/8"H. FEATURE STONE BORDER STRIP TJI Jsts SLOPE (1%) PAVERS TO AGO TRENCH DRAIN 2x6 Sill Plate on Foam Gasket COMPACTED GRANULAR 1/2" dia. Anchor PAVER BASE Bolts @ 72°c/c PROVIDE GEO-MEMBRANE FABRIC -(2)10M Rebars CLEAN SAND BACK FILL BETWEEN ALL DISSIMILAR FILL MATERIALS (Continuous) FILTER WRAP DRAINAGE PIPE -MECH, FASTENED 1 1/2" EXTRUDED RIGID INSULATION TAPE AND SEALALL SEAMS W/ HEAT TRACE WIRE WITHIN CONNECTED TO PERIMETER: (Down to Footing) PLATON DRAINAGE LAYER BELOW GRADE DRAIN AT FOOTING C/W TERMINATION STRIP +/- 8" ABOVE PROVIDE GEC-MEMBRANE FABRIC FINISHED GRADE BETWEEN ALL DISSIMILAR FILL MATERIALS COMPACTED GRANULAR FREE FLOWING FILL FOUNDATION CURB DETAIL (Court Yard))

SCALE: 3/4"=1'-0"

2x8 Sill Plate Bolted to Steel Beam with 1/2" dia. Bolt @ 24"c/c Staggered Too Mounted Joist Hanger T.O.FW. W250 x 39 Steel Beam (See Plan) End Welded to Steel Plate bearg on Foundation Wall 13" x 4" x 1/2"th. Steel Plate 4 1/2" 4 1/2" 1/2" dia. Expansion Bolt (1) Each Side of Beam Non Shrink Grout -SIDE VIEW FLUSH BEAM DETAIL AND ANCHORAGE

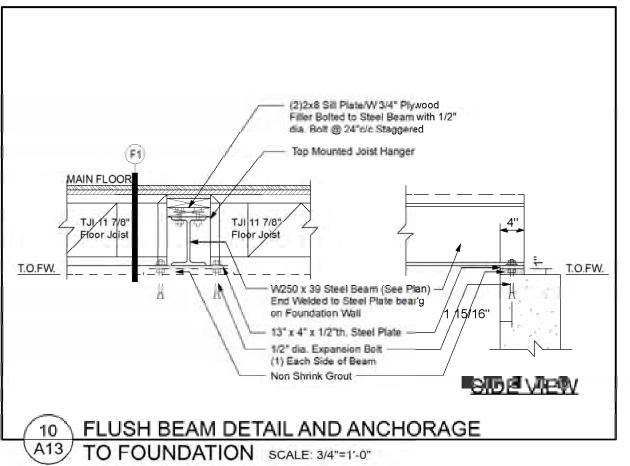



A13 | SCALE: 3/4"=1'-0"

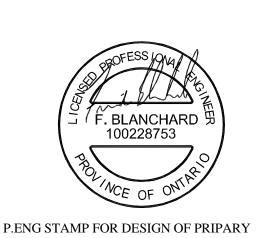


STRUCTURAL ELEMENTS ONLY. DEC. 6, 2019


A13 TO FOUNDATION SCALE: 3/4"=1'-0"

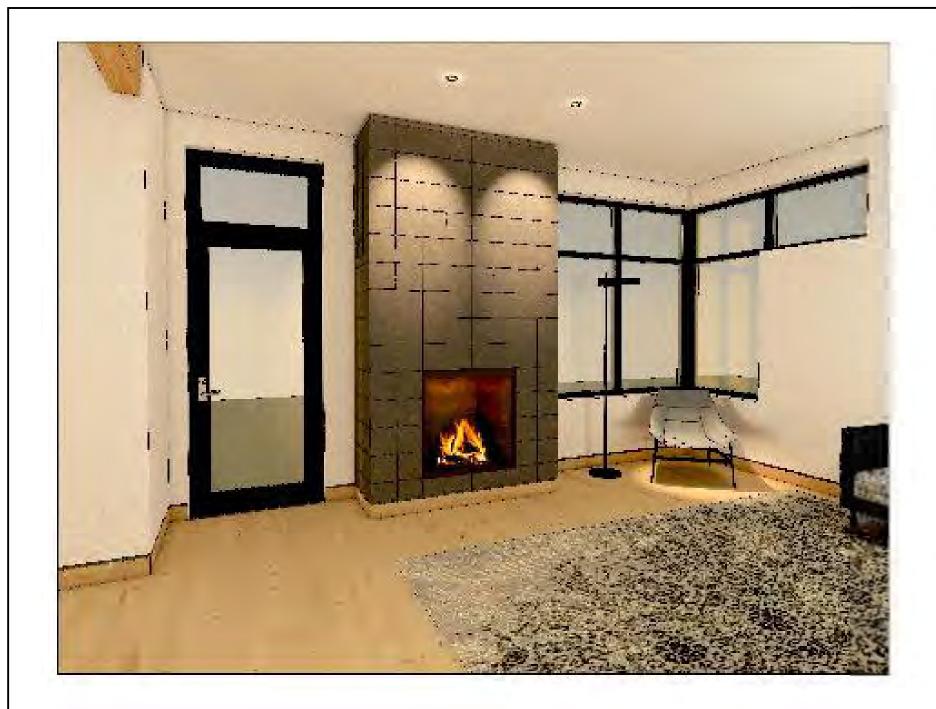

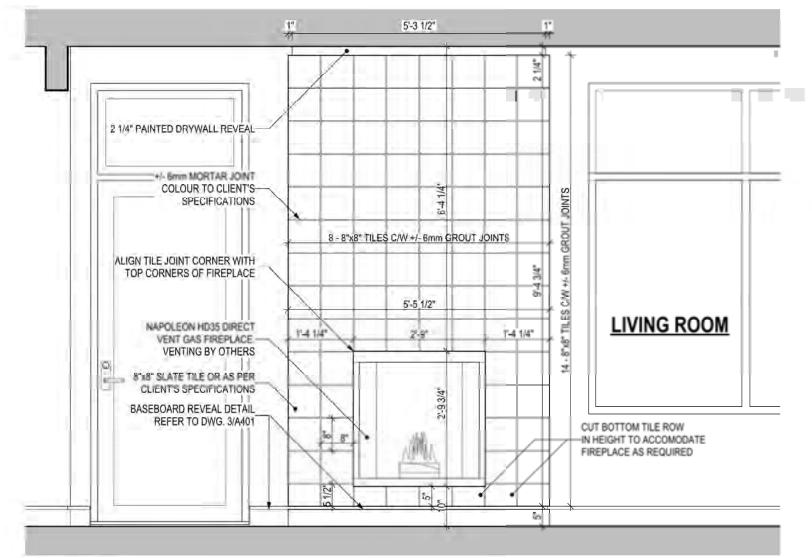

1 FIREPLACE FRONT VIEW ELEVATION
SCALE: 1/2"=1'-0"

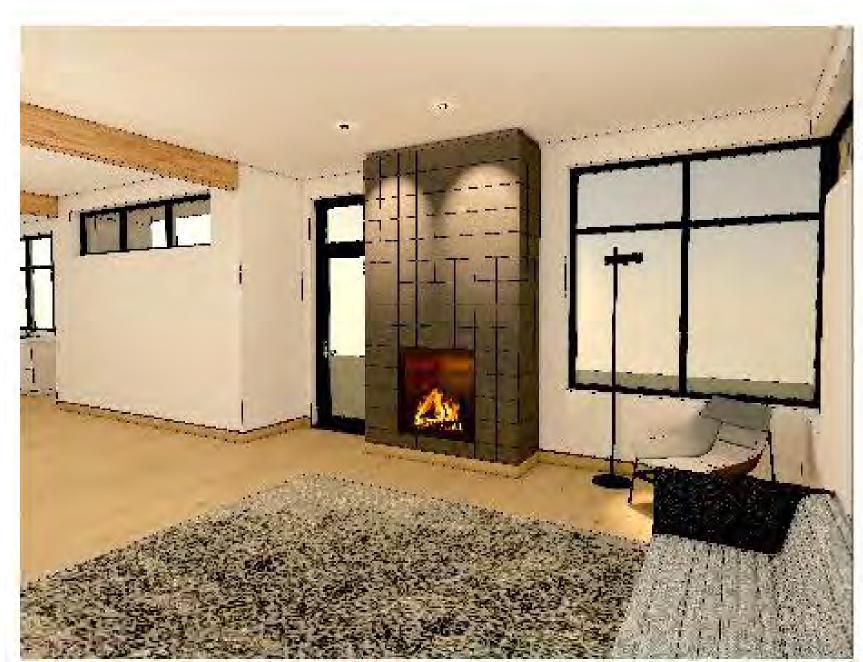

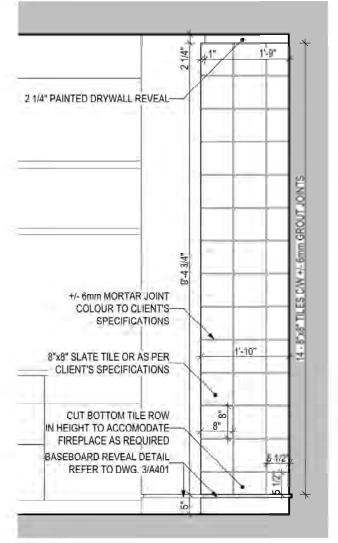

2 FIREPLACE SIDE VIEW
A14 ELEVATION SCALE: 1/2"=1'-0"




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DATE	DESCRIPTION	REV
The second secon	Construction Plan Prelim Stage	01
11/2/2019	Construction Plan Prelim Stage2	02
11/6/2019	Issued to Truss Manufacturer	03
11/8/2019	Construction Plan Prelim Stage3	04
11/11/2019	Issued for Structural Review	05
MICHIGANIAN PROPERTY AND ADDRESS OF THE PARTY OF THE PART	Modified Bathrm & Lowered Roof	06
11/26/2019	Revised to Architect Comments	07

A.L. Claiforni

CASA BORRACCI

DESIGNED BY: ROBERTSON MARTIN ARCHITECTS

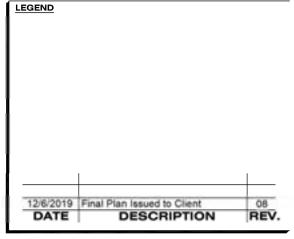PROJECT INFORMATION
NEW RESIDENCE
for M.& Mrs BORRACCI
880 Duberry St. Ottawa
PRAWING TITLE
FIREPLACE DETAILS


PROJECT DIRECTOR
FRANK MURRAY

AL-B9-157


Oct 2019

N/A


As Shown A14 of 19

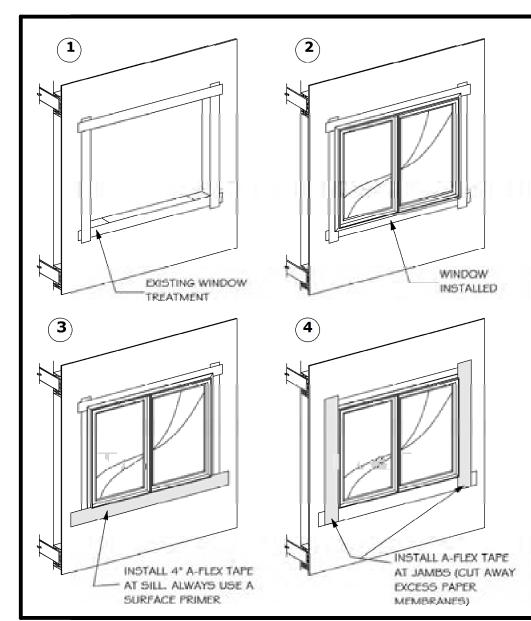


1C Window Treatment, Part 1

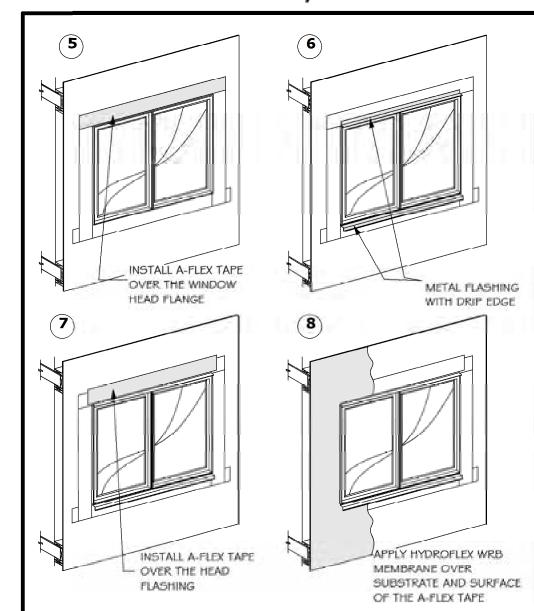


1C Window Treatment, Part 2

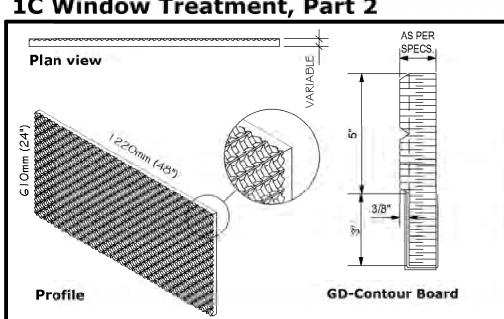


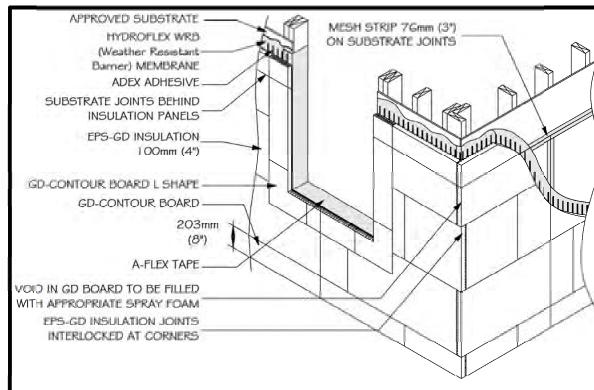


1A Insulation Installation (Optional)

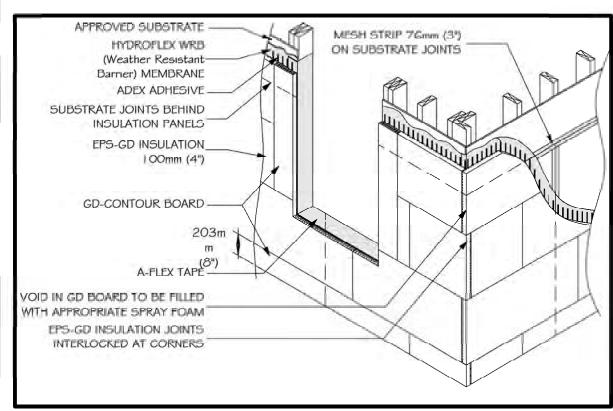


1A Insulation Installation

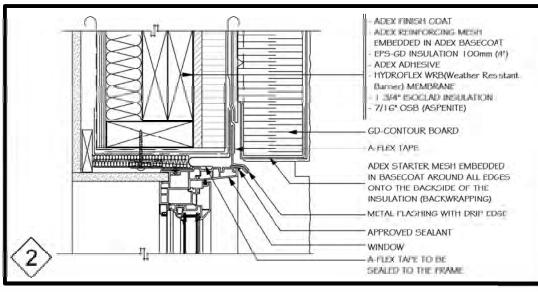

Window Head

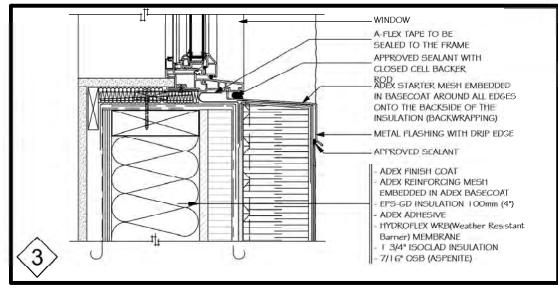

Window Sill

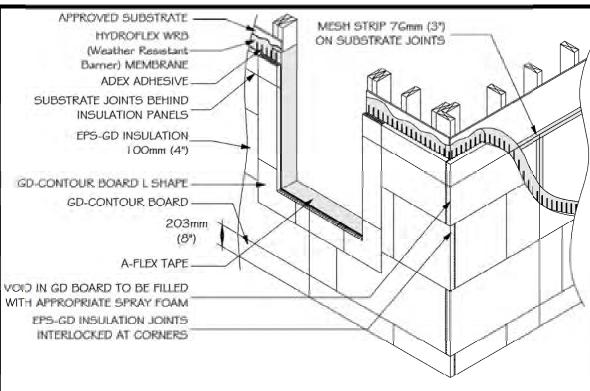

AT CORNERS 203mm (8") MIN. (TWO LAYERS) MINIMUM GAP OF 13mm ADEX STARTER MESH STRIP 240X305mm (1/2") FOR SEALANT JOINT (9 1/2" X 12") INSTALLED ON A 45 DEG ANGLE AT CORNER OF OPENINGS 203mm (8" MINIMUM ADEX REINFORCING MESH TO BE OVERLAPPED 64mm) (2 1/2") AT JOINTS ADEX STARTER MESH EMBEDDED IN BASE COAT AROUND ALL EDGES ONTO THE BACKSIDE OF


THE INSULATION (BACKWRAPPING)

-GD CONTOUR BOARD

DOUBLE WRAF OUTSIDE CORNERS USING

ADEX REINFORCING MESH OVERLAPPED

1B Reinforcing Mesh Installation

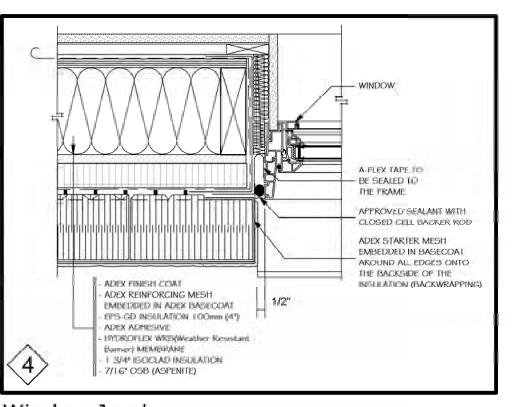

Window Jamb



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CONSTRUCTION PROJECT MANAGEMENT BY PARAGON HOMES

CUSTOM ENGINEERED HOME PACKAGES-KIT BY PARAGON HOMES

LEGEND

	DESCRIPTION	REV.
12/6/2019	Final Plan Issued to Client	08

FOR ALL TECHNICAL ISSUE OR QUESTIONS, CONTACT PARAGON HOMES BEFORE CONTINUING THE WORK.

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DO NOT SCALE THE DRAWINGS.

DATE	DESCRIPTION	REV
	Construction Plan Prelim Stage	01
	Construction Plan Prelim Stage2	02
	Issued to Truss Manufacturer	03
11/8/2019	Construction Plan Prelim Stage3	04
11/11/2019	Issued for Structural Review	05
11/21/2019	Modified Bathrm & Lowered Roof	06
The second secon	Revised to Architect Comments	07

F.M

CASA BORRACCI

DESIGNED BY: ROBERTSON MARTIN ARCHITECTS

PROJECT INFORMATION NEW RESIDENCE for M.& Mrs BORRACCI 880 Duberry St. Ottawa **DRAWING TITLE** STUCCO DETAILS

PROJECT DIRECTOR

FILE NAME N/A

FRANK MURRAY


PROJECT NUMBER AL-B9-157

Oct 2019


As Shown

A15 of 19

DRAWING NUMBER

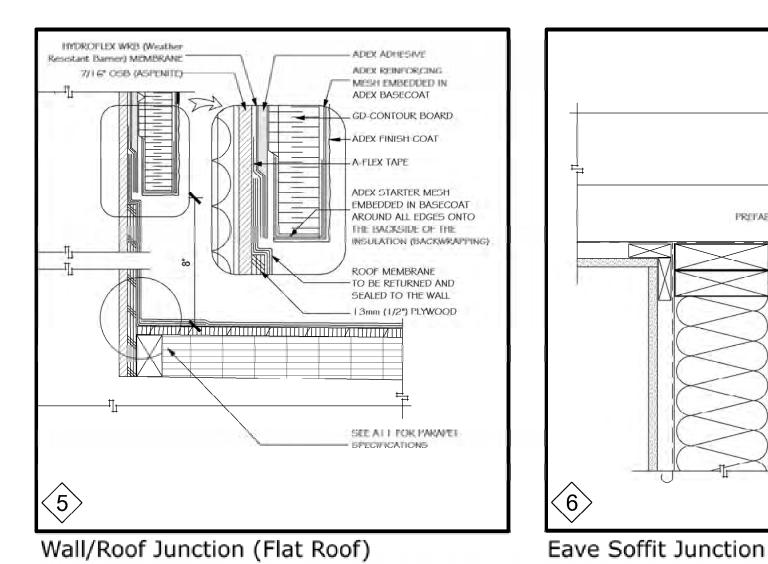


PREFAB TRUSSES ALUMINUM SOFFIT ADEX STARTER MESH EMBEDDED IN BASECOAT AROUND ALL EDGES AND ONTO THE MEMBRANE (BACKWRAPPING) STAY IN PLACE MECHANISM 7/16" OSB (ASPENITE) 1 3/4" ISOCLAD INSULATION HYDROFLEX WRB (Weather Resistant Barrier) MEMBRANE ADEX ADHESIVE EPS-GD INSULATION 50mm @ 127mm (2" @ 5") ADEX REINFORCING MESH EMBEDDED IN ADEX BASECOAT ADEX FINISH COAT

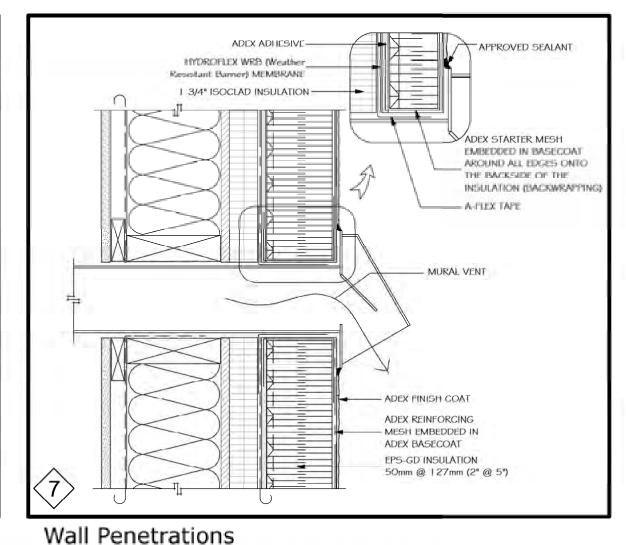

MAISONS 710-1180 Chemin d'Aylmer Gatineau, Qc., J9H 0G5 OFFICE: (Qe) 1-819-503-6820 (Qn) 1-613-789-0220 CEL: 819-743-9220 WWW.PARAGONHOMES.CA

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11/6/2019	Issued to Truss Manufacturer	03
11/8/2019	Construction Plan Prelim Stage3	04
11/11/2019	Issued for Structural Review	- 05
11/21/2019	Modified Bathrm & Lowered Roof	06
	Revised to Architect Comments	07

F.M

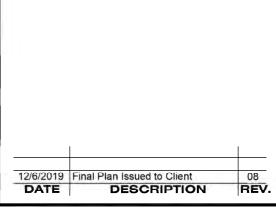CASA BORRACCI


DESIGNED BY: ROBERTSON MARTIN ARCHITECTS


PROJECT INFORMATION NEW RESIDENCE for M.& Mrs BORRACCI 880 Duberry St. Ottawa DRAWING TITLE STUCCO DETAILS

PROJECT DIRECTOR FILE NAME N/A FRANK MURRAY

PROJECT NUMBER AL-B9-157

Oct 2019 DRAWING NUMBER

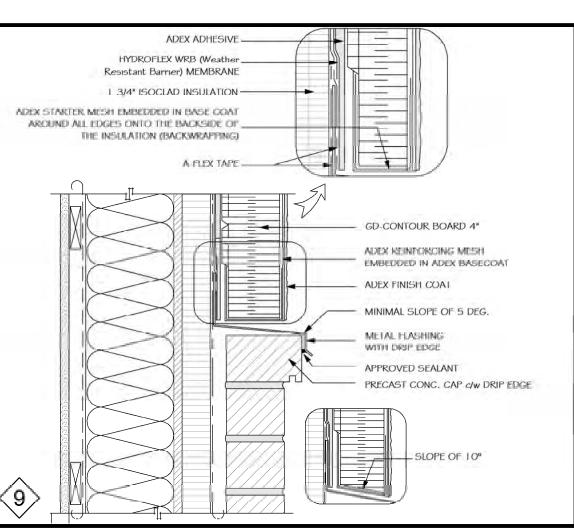

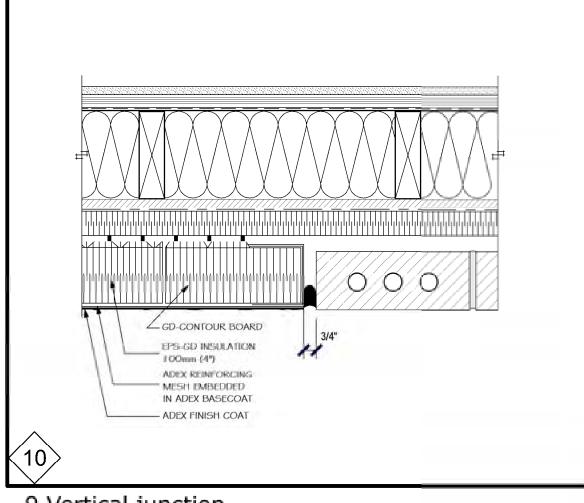

9 Vertical junction

8 Termination At Grade-Court Yard

HYDROFLEX WRB (Weather

APPROVED SUBSTRATE

ADEX ADHESIVE.

A-FLEX TAPE-

EPS-GD INSULATION LOOmm (4")

EMBEDDED IN ADEX BASECOAT

SLOPE OF 10°

ADEX REINFORCING MESH

ADEX FINISH COAT

METAL FLASHING

/ WITH DRIP EDGE

GD-CONTOUR BOARD

Resistant Barrier) MEMBRANE-


ADEX STARTER MESH EMBEDDED IN BASECOAT.

AROUND ALL EDGES ONTO THE BACKSIDE OF-

THE INSULATION (BACKWRAPPING)

AND SEALED TO THE SUBSTRATE

A-PLEX TAPE TO BE RETURNED

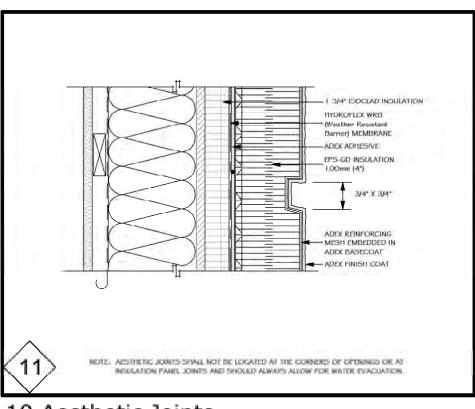

ADEX FINISH COAT ADEX REINFORCING MESH EMBEDDED IN ADEX BASECOAT EPS-GD INSULATION 50mm @ 127mm (2" @ 5") BLOCKING SECURED TO FRAMING APPROVED SEALANT WITH CLOSED CELL BACKER - STAINLESS STEEL PIPE SLEEVE TILL THE HOLE WITH COMPATIBLE SEALANT BEFORE INSTALLING THE SLEEVE ADEX ADHESIVE HYDROFLEX WRB (Weather Resistant Barrier) MEMBRANE 1 3/4" ISOCIAD INSULATION

11- Accessories Attachment

9 Horizontal Junction

10 Aesthetic Joints

As Shown

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	WINDOW SCHEDULE							
#	FLR	ROOM NAME	QTY	DESCRIPTION	DIMENSIONS W X H	GLAZING TYPE	HEIGHT FROM FLR	AREA (SQFT)
W01	0	EXERCISE RM	1	RIGHT SLIDING	78"X36"RS	DOUBLE PANE	103"	19.5
W02	0	BEDRM #4	1	RIGHT SLIDING	78"X36"RS	DOUBLE PANE	103"	19.5
W03	0	RECREATION / WORKSHOP	1	RIGHT SLIDING	78"X36"RS	DOUBLE PANE	103"	19.5
W04	1	BEDRM #2	1	DOUBLE AWNING-BOTTOM OPENS	40"X60"FA	DOUBLE PANE	83"	16.67
W05	1	BEDRM #2	1	FIXED GLASS	116"X24"FX	DOUBLE PANE	107"	19.33
W06	1	KITCHEN	1	FIXED GLASS	40"X41"FX	DOUBLE PANE	83"	11.39
W07	1	KITCHEN	1	FIXED GLASS	78"X24"FX	DOUBLE PANE	107"	13.0
W08	1	KITCHEN/DECK	1	FIXED GLASS	116"X41"FX	DOUBLE PANE	83"	33.03
W09	1	KITCHEN/DECK	1	MULLED UNIT-SINGLE AWNING + FIXED GLASS + SINGLE AWNING	116"X24"	DOUBLE PANE	107"	19.33
W10	1	DINING/DECK	1	FIXED GLASS	116"X24"FX	DOUBLE PANE	107"	19.33
W11	1	LIVING	1	MULLED UNIT-FIXED GLASS LEFT + DOUBLE AWNING RIGHT, BOTTOM OPENS	78"X60"	DOUBLE PANE	83"	32.5
W12	1	LIVING	1	DOUBLE AWNING-BOTTOM OPENS	40"X60"FA	DOUBLE PANE	83"	16.67
W13	1	LIVING	2	FIXED GLASS	78"X24"FX	DOUBLE PANE	107"	13.0
W14	1	BEDRM #3	1	DOUBLE AWNING-BOTTOM OPENS	40"X60"FA	DOUBLE PANE	83"	16.67
W15	1	BEDRM #3	1	FIXED GLASS	40"X24"FX	DOUBLE PANE	107"	6.67
W16	1	ENSUITE	1	MULLED FIXED GLASS LF + SINGLE AWNING RI	78"X24"	DOUBLE PANE	107"	13.0
W17	1	MASTER BDRM	1	DOUBLE AWNING-BOTTOM OPENS	40"X60"FA	DOUBLE PANE	83"	16.67
W18	1	MASTER BDRM	1	FIXED GLASS	116"X24"FX	DOUBLE PANE	107"	19.33
W19	1	HALL/COURT YARD	2	FIXED GLASS	174 1/16"X95 1/2"FX	DOUBLE PANE	95 1/2"	115.44
W22	1	BATH/OPEN BELOW	1	FIXED GLASS (Frosted) IN WOOD FRAME	48"X24"FX	SINGLE PANE	96"	8.0
TOT								576.97

RS = RIGHT SLIDING B = BOTTOM

HL = HINGES LEFT LHL = LEFT HINGE LEFT MULLED = WINDOWS JOINED TOGETHER

P.S.: ALL DIMENSIONS ARE FRAME NOT R.O.

HR = HINGES RIGHT RHL = RIGHT HINGE RIGHT 1- REFER TO ELEVATIONS FOR WINDOW STYLE BUT NOTE THAT THE EXACT WINDOW STYLE SHALL BE CONFIRM BY THE HOME OWNERS PRIOR TO ORDERING OR MANUFACTURING. SHOP DRAWINGS SHALL BE PROVIDED TO THE OWNER AND GENERAL CONTRACTOR FOR REVIEW PRIOR TO PLACING ORDER. ANY VARIANCE SHALL BE RESOLVED BY THE OWNER/GENERAL CONTRACTOR.

2- ALL WINDOWS ARE TO BE 100% BLACK ALUM. AND ARE TO MEET THE MINIMUM "U" VALUE SPECIFIED IN THE ONTARIO BUILDING CODE SECTION OR ARE TO BE BETTER.

	,	_						DOOR SCI	HEDULE		
#	QTY	FLR	EX/IN	ROOM NAME	DOOR LEAF DIMENSIONS	FRAME DIMENSION	TYPE	LEAF MAT'L	HARDWARE	NOTES	GLASS AREA SQFT
01	1	1	EX	ENTRY	42"X84"	71" X 107"	MULLED UNIT	WOOD	KEY IN KNOB, DEADBOLT, 1 1/2 PAIR OF HINGES LATCH STRIKE, WEATHERSTRIP	UNIT C/W 1 SIDELIGHT & TRANSOM. TOTAL HEIGHT OF 107" TO MATCH TOP OF HOUSE WINDOW. SBO	N/A
002	1	1	IN	ENTRY/ENTRY CLOSET	(2)30"X96"		DOUBLE HINGED	WOOD	PASSAGE KNOB, 1 1/2 PAIR OF HINGES, LATCH STRIKE	SBO	
03	1	1	IN	BEDRM #2/HALL	34"X96"		HINGED	WOOD	PASSAGE KNOB, HINGES, LATCH STRIKE, LOCKSET	SBO	
004	1	1	IN	HALL CLOSET/HALL	(2)30"X96"		DOUBLE HINGED	WOOD	PASSAGE KNOB, HINGES, LATCH STRIKE	SBO	
05	1	1	EX	HALL/GARAGE	36"X80"		HINGED	INS. MTL	KEY IN KNOB, DEADBOLT, 1 1/2 PAIR OF HINGES LATCH STRIKE, WEATHERSTRIP, SELF CLOSER	SBO	
006	1	1	EX	GARAGE	16'0" X 7"0"		GARAGE	WOOD	GARAGE DOOR MOUNTING KIT C/W GARAGE DOOR OPENER	SBO	
07	1	1	EX	GARAGE	(2)36"X80"		DOUBLE HINGED	INS. MTL	KEY IN KNOB, DEADBOLT, 1 1/2 PAIR OF HINGES LATCH STRIKE, WEATHERSTRIP	SBO	
800	1	1	IN	BATH/HALL	32"X96"		HINGED	WOOD	PASSAGE KNOB, HINGES, LATCH STRIKE, LOCKSET	SBO	
09	1	1	IN	LAUNDRY/HALL	36"X96"		POCKET	WOOD	MOUNTING HARDWARE	SBO	
10	1	1	IN	W.I.P./KITCHEN	34"X96"		POCKET	WOOD	MOUNTING HARDWARE	SBO	1
11	1	1	IN	BEDRM #2/BEDRM #2 CLOSET	(2)30"X96"		DOUBLE HINGED	WOOD	PASSAGE KNOB, HINGES, LATCH STRIKE	SBO	
12	1	1		KITCHEN/DECK	36"X104 9/16"		MULLED UNIT	_			
13	1	1		LIVING/DECK	36"X104 9/16"		MULLED UNIT		KEY IN KNOB, DEADBOLT, 1 1/2 PAIR OF HINGES LATCH STRIKE, WEATHERSTRIP	UNIT C/W TRANSOM. TOTAL HEIGHT OF 107 TO MATCH TOP OF HOUSE WINDOW. SBO	16.41
14	1	1	EX	DINING/COURT YARD	129"X98		QUAD SLIDER	ALUM. CLAD WOOD		SBO	87.79
15	1	1	IN	BEDRM #3/HALL	34"X96"		HINGED	WOOD	PASSAGE KNOB, HINGES, LATCH STRIKE, LOCKSET	SBO	
16	1	1	IN	BEDRM #3/BEDRM#3 CLOSET	(2)30"X96"		DOUBLE HINGED	WOOD	PASSAGE KNOB, HINGES, LATCH STRIKE	SBO	
17	1	1	IN	MASTER BDRM/HALL	34"X96"		HINGED	WOOD	PASSAGE KNOB, HINGES, LATCH STRIKE, LOCKSET	SBO	
18	1	1	IN	MASTER BDRM/W.I.C.	32"X96"		POCKET	WOOD	MOUNTING HARDWARE	SBO	
19	1	1	IN	ENSUITE/W.I.C.	32"X96"		POCKET	WOOD	MOUNTING HARDWARE, LOCKSET	SBO	1
20	1	1	EX	HALL/COURT YARD	129"X98		QUAD SLIDER	ALUM. CLAD WOOD		SBO	87.79
21		0	IN	STOR./HALL	36"X80"		HINGED	WOOD	PASSAGE KNOB, HINGES, LATCH STRIKE	SBO	
22	1	0	IN	THEATER RM/HALL	32"X80"		HINGED	WOOD	PASSAGE KNOB, HINGES, LATCH STRIKE	SBO	
23	1	0	IN	RECREATION / WORKSHOP/THEATER RM	(2)36"X80"		DOUBLE POCKET	WOOD	MOUNTING HARDWARE	SBO	
24	1	0	IN	BATH #2/HALL	32"X80"		HINGED	WOOD	PASSAGE KNOB, HINGES, LATCH STRIKE, LOCKSET	SBO	
25	1	0	IN	BEDRM #4/HALL	34"X80"		HINGED	WOOD	PASSAGE KNOB, HINGES, LATCH STRIKE, LOCKSET	SBO	
26	1		IN	BEDRM #4/CLOSET	(2)30"X80"			WOOD	PASSAGE KNOB, HINGES, LATCH STRIKE	SBO	
)27	1	0	IN	HALL/EXERCISE RM	(2)36"X80"		DOUBLE HINGED	WOOD	PASSAGE KNOB, HINGES, LATCH STRIKE PASSAGE KNOB, HINGES, LATCH STRIKE	SBO SBO	

P.S.: ALL DIMENSIONS IN DOOR SCHEDULE ARE EITHER FRAME OR LEAF NOT R.O. (ROUGH OPENING)

- ALL EXTERIOR DOOR SHALL HAVE WEATHERSTRIPPING.

- ALL FRAME DIMENSIONS ARE APPROXIMATE. REFER To SUPPLIER'S FOR EXACT DIMENSIONS BEFORE FRAMING.

SbO = Style by Others (See Client)




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CONSTRUCTION PROJECT MANAGEMENT BY PARAGON HOMES

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CASA BORRACCI

DESIGNED BY: ROBERTSON MARTIN ARCHITECTS

PROJECT INFORMATION **NEW RESIDENCE** for M.& Mrs BORRACCI 880 Duberry St. Ottawa DRAWING TITLE

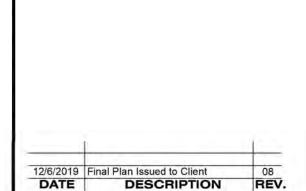WINDOW & DOOR SCHEDULE

PROJECT DIRECTOR FRANK MURRAY

TOTAL = 208.40

FILE NAME N/A


PROJECT NUMBER AL-B9-157

Oct 2019

DRAWING NUMBER **A17** of 19 As Shown

SITE DATA		
ZONE: ZONE R10		
ZONE PROVISIONS	REQUIRED	PROVIDED
LOT WIDTH::	15.0m MIN.	25.69 m
LOT AREA::	450 sqm	805 sqm
GROSS AREA: House = 221.00 sqm (2378.82 sqft) Garage = 55.33 sqm (595.56 sqft) Court Yard = 16.15 sqm (173.83 sqft)		
TOTAL BLDG AREA (Footprint): 292.48 sqm (3148.21 sqft)		292.48 sqm
MAXIMUM BUILDING HEIGHT (from existing average grade)	8.0m	5.00m
FRONT YARD BACKSET:	6.0m MIN.	6.051 m
REAR SIDE YARD BACKSET: (28% of lot depth)	8,76m MIN.	8.95 m
SIDE YARD BACKSET (NORTH ELEVATION): * MIN. TOTAL OF 3.0mW/ ONE MIN. YARD NO LESS THAN 1.2	VARIES*	2.324 m
SIDE YARD BACKSET (SOUTH ELEVATION): * MIN. TOTAL OF 3.0mW/ ONE MIN. YARD NO LESS THAN 1.2	VARIES *	1.275 m
PARKING REQUIREMENTS:	N/A	
BICYCLE PARKING REQUIREMENTS:	N/A	
AMENITY AREA:	N/A	




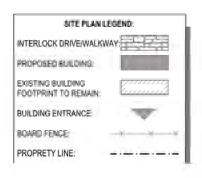



CONSTRUCTION PROJECT MANAGEMENT BY PARAGON HOMES

CUSTOM ENGINEERED HOME
PACKAGES-KIT BY PARAGON HOMES

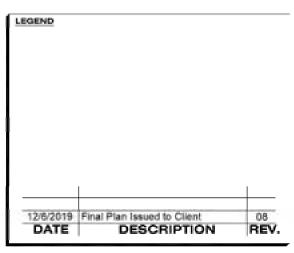

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Construction Plan Prelim Stage DESCRIPTION	01 REV
	and the street of the same
Construction Plan Prelim Stage 2	0.2
	03
	04
The state of the s	05
Modified Bathrm & Lowered Roof	06
	07
	Construction Plan Prelim Stage3 Issued to Truss Manufacturer

A.L. Ola-Jan

CASA BORRACCI

DESIGNED BY: ROBERTSON MARTIN ARCHITECTS

PROJECT INFORMATION
NEW RESIDENCE
for M.& Mrs BORRACCI
880 Duberry St. Ottawa
PRAWING TITLE
SITE PLAN

FRANK MURRAY


FILE NAME N/A

PROJECT NUMBER C

AL-B9-157

Oct 2019

As Shown A18 of 19

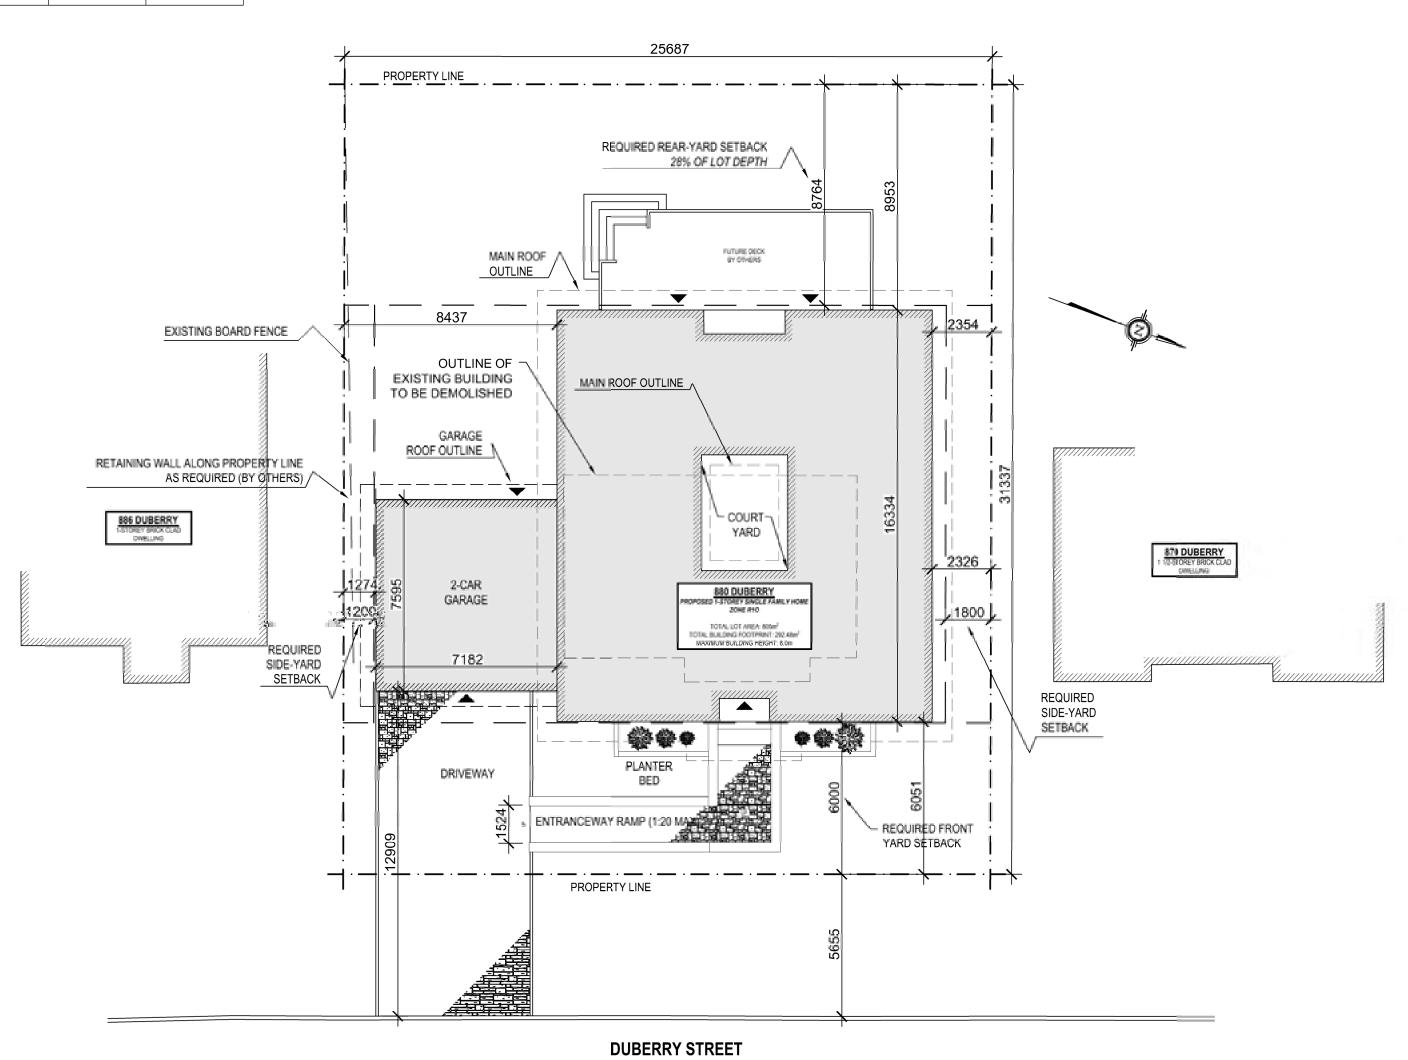

SITE PLAN

SCALE 1:150

